December 19, 2022

ADDENDUM NUMBER ONE (1)

Project:

Tippah County Hospital

EMS Building PN: 22005

FROM:

Dean Architecture, P.A.

661 Sunnybrook Road, Suite 140

Ridgeland, MS 39157

(601) 939-7717

The following additions, changes, clarifications and/or substitutions to the Project Drawings as indicated, are hereby made a part of the Contract Documents. Acknowledge receipt of this Addendum by inserting its number and date in the Proposal Form where indicated.

General Clarifications:

Item #1: Section 040600 Mortar - color of mortar to match new hospital. See paragraph 2.02.D.1 -

Lafarge Ivory Buff.

Item #2: Section 104400 Fire Protection Specialties - provide (4) four 10 lb - 4A -80B:C Fire

extinguishers for this project: 3 in cabinets. 1 on wall mounted bracket as shown on drawings.

Item #3: Room Signs will be provided and installed by the Owner.

Item #4: A building plaque is not required for this project.

Item #5: Sheet A101 Floor plan - Dotted in equipment, furniture, tables, body cooler, etc. shown on

floor plan to be provided and installed by the Owner unless noted otherwise.

Item #6: A construction job sign is not required for this project.

Architectural Specifications:

Item #1: Section 004100 - Bid Form, as follows:

Replace Section in its entirety – changed description of alternate No. 1.

Item #2: Section 012300 - Alternates, as follows:

Replace Section in its entirety – changed description of alternate No. 1.

Item #3: Section 062000 – Finish Carpentry, as follows:

Replace Section in its entirety – clarified Hardiboard siding and trim.

Item #4: Section 133419 Metal Building Wall and Roof System, paragraph 1.06A, change "five year"

warranty to read "twenty year" warranty.

Tippah County Hospital EMS Building Addendum #1 December 19, 2022

Refer to Drawings:

Item #1: Add sheet A201-A, Alternate Building Elevation dated Dec 19, 2022 to the bid documents.

Item #2: Sheet A901 – remove reference to plastic laminate cabinet finishes and change to painted

birch cabinets per specifications section 064100. See revised Sheet A901 attached.

Civil

SEE ATTACHED CIVIL ITEMS PROVIDED BY McMASTER & ASSOCIATES

Mechanical

SEE ATTACHED MECHANICAL ITEMS PROVIDED BY GSK

Electrical

SEE ATTACHED ELECTRICAL ITEMS PROVIDED BY JON D. RICE & ASSOCIATES

END OF ADDENDUM NUMBER ONE (1)

Dean Architecture, PA

Kenneth A. Oubre, AIA, Principal

PLEASE ATTACH THIS ADDENDUM TO THE INSIDE FRONT COVER OF EACH SET OF SPECIFICATIONS.

PN: 22005

Addendum #1 - page 2

SECTION 004100 BID FORM

THE PROJECT AND THE PARTIES

1.01	то	:
	A.	Owner 1. Tippah County Board of Supervisors Ripley, MS 38663
1.02	FO	R:
	A.	Tippah County Hospital - EMS Building
1.03	DA	TE: (BIDDER TO ENTER DATE)
1.04	SU	BMITTED BY: (BIDDER TO ENTER NAME AND ADDRESS)
	A.	Bidder's Full Name Address City, State, Zip
1.05	OF	FER
	A.	Having examined the Place of The Work and all matters referred to in the Instructions to Bidders and the Contract Documents prepared by Dean Architecture, P.A. for the above mentioned project, we, the undersigned, hereby offer to enter into a Contract to perform the Work for the Sum of:
	B.	Base Bid
		(\$), in lawful money of the United States of America.
	C.	Deductive Alternate #1 (Furnish and install Hardiboard Siding in lieu of Metal siding)
		(\$), in lawful money of the United States of America.
	D.	Add Alternate #2 (Furnish and install Emergency Generator per electrical drawings)
		(\$), in lawful money of the United States of America.
	E.	We have included the required performance assurance bonds in the Bid Amount as required by the Instructions to Bidders.
	F.	All applicable federal taxes are included and State of Mississippi taxes are included in the Bid Sum.
	G.	All Cash Allowances described in Section 012100 are included in the Bid Sum.
1.06	AC	CEPTANCE
	A.	This offer shall be open to acceptance and is irrevocable for ninety days from the bid closing date.
	B.	 If this bid is accepted by Owner within the time period stated above, we will: Execute the Agreement within seven days of receipt of Notice of Award. Furnish the required bonds within seven days of receipt of Notice of Award.
	C.	If this bid is accepted within the time stated, and we fail to commence the Work or we fail to provide the required Bond(s), the security deposit shall be forfeited as damages to Owner by reason of our failure. Iimited in amount to the lesser of the face value of the security deposit or

DA 12/2022 PN: 22005 004100-1

D. In the event our bid is not accepted within the time stated above, the required security deposit shall be returned to the undersigned, in accordance with the provisions of the Instructions to

the difference between this bid and the bid upon which a Contract is signed.

1.07 CONTRACT TIME

A. If this Bid is accepted, we will:

Complete the Work in ____ calendar days from Notice to Proceed. (Bidder to enter number of calender days to complete project)

2.01 ADDENDA

A. The following Addenda have been received. The modifications to the Bid Documents noted below have been considered and all costs are included in the Bid Sum.

1. Addendum # ____ Dated _____.

2. Addendum # ____ Dated ____.

3. Addendum # ____ Dated ____.

4. Addendum # ____ Dated ____.

2.02 BID FORM SIGNATURE(S)

A. The Corporate Seal of

(Bidder - print the full name of your firm)

was hereunto affixed in the presence of:

Bidders; unless a mutually satisfactory arrangement is made for its retention and validity for an

extended period of time.

(Authorized signing officer, Title)

B. If the Bid is a joint venture or partnership, add additional forms of execution for each member of the joint venture in the appropriate form or forms as above.

END OF BID FORM

SECTION 012300 ALTERNATES

PART 1 GENERAL

1.01 SECTION INCLUDES

A. Description of Alternates.

1.02 ACCEPTANCE OF ALTERNATES

- A. Alternates quoted on Bid Forms prepared by the Architect will be reviewed and accepted or rejected at Owner's option. Accepted alternates will be identified in the Owner-General Contractor Agreement.
- B. Coordinate related work and modify surrounding work to integrate the Work of each Alternate.

1.03 SCHEDULE OF ALTERNATES

- A. Alternate No. 1 Hardiboard Siding Provide deductive price to furnish and install painted Hardiboard siding in lieu of prefinished metal siding as shown on the drawings. (Sheet A201A)
- B. Add Alternate No. 2 Provide price to furnish and install the Emergency Generator including all associated accessories required per the Electrical Drawings.

PART 2 PRODUCTS - NOT USED PART 3 EXECUTION - NOT USED

END OF SECTION

DA 12/2022 PN: 22005 012300-1

SECTION 062000 FINISH CARPENTRY

PART 1 GENERAL

1.01 SECTION INCLUDES

- A. Finish carpentry items.
- B. Wood door frames. KD frames with solid core wood doors Flush.
- C. Hardiplank wall board and trim.

1.02 RELATED REQUIREMENTS

- Section 061000 ROUGH CARPENTRY: Support framing, grounds, and concealed blocking.
- B. Section 081416 Flush Wood Doors.

1.03 REFERENCE STANDARDS

A. AWI/AWMAC/WI (AWS) - Architectural Woodwork Standards; 2014.

1.04 SUBMITTALS

- A. See Section 013000 Administrative Requirements for submittal procedures.
- B. Product Data:
 - 1. Provide data on materials and application instructions.
- C. Shop Drawings: Indicate materials, component profiles, fastening methods, jointing details, and accessories.
 - 1. Provide the information required by AWI/AWMAC/WI (AWS).

1.05 QUALITY ASSURANCE

- A. Fabricator Qualifications: Company specializing in fabricating the products specified in this section with minimum five years of documented experience.
- B. Perform work in accordance with AWI Architectural Woodwork Quality Standards Illustrated, Custom grade.

1.06 DELIVERY, STORAGE, AND HANDLING

A. Protect work from moisture damage.

PART 2 PRODUCTS

2.01 FINISH CARPENTRY ITEMS

- A. Quality Grade: Unless otherwise indicated provide products of quality specified by AWI/AWMAC/WI (AWS) for Custom Grade.
- B. Surface Burning Characteristics: Provide materials having fire and smoke properties as required by applicable code.
- C. Interior Woodwork Items:
 - 1. Door Frames: 1 x 4 Fir split jamb prepare for paint finish.
 - 2. Doors Masonite flush HD particle board cores.- Painted

2.02 WOOD-BASED COMPONENTS

A. Wood fabricated from old growth timber is not permitted.

2.03 LUMBER MATERIALS

A. Softwood Lumber: Clear fir species for interior painted trim - plain sawn, maximum moisture content of 6 percentwith vertical grain,.

2.04 SHEET / SIDING PANEL MATERIALS

A. Hardiplank horizontal lap siding panels (6" exposure) and trim (1 x 4) (Alternate No. One) equal to products manufactured by James Hardie Building Products, Inc. 10901 Elm Avenue, Fontana, CA. See drawings for sizes and profiles.

2.05 ADHESIVES

A. Adhesive: Suitable for the purpose; not containing formaldehyde or other volatile organic compounds. Type recommended by laminate manufacturer to suit application.

2.06 ACCESSORIES

- A. Lumber for Shimming and Blocking: Softwood lumber of pine species.
- B. Primer: Alkyd primer sealer.
- C. Wood Filler: Solvent base, tinted to match surface finish color.

2.07 FABRICATION

- A. Shop assemble work for delivery to site, permitting passage through building openings.
- B. When necessary to cut and fit on site, provide materials with ample allowance for cutting. Provide trim for scribing and site cutting.

PART 3 EXECUTION

3.01 EXAMINATION

- A. Verify adequacy of backing and support framing.
- B. Verify mechanical, electrical, and building items affecting work of this section are placed and ready to receive this work.

3.02 INSTALLATION

- A. Install work in accordance with AWI/AWMAC/WI (AWS) requirements for grade indicated.
- B. Set and secure materials and components in place, plumb and level.
- C. Carefully scribe work abutting other components, with maximum gaps of 1/32 inch. Do not use additional overlay trim to conceal larger gaps.

3.03 PREPARATION FOR SITE FINISHING

- A. Set exposed fasteners. Apply wood filler in exposed fastener indentations. Sand work smooth.
- B. Site Finishing: See Section 099000.
- C. Before installation, prime paint surfaces of items or assemblies to be in contact with cementitious materials.

3.04 TOLERANCES

- A. Maximum Variation from True Position: 1/16 inch.
- B. Maximum Offset from True Alignment with Abutting Materials: 1/32 inch.

END OF SECTION



December 19, 2022

ADDENDUM NO. ONE (1) - CIVIL ENGINEERING ITEMS

Tippah County Hospital – EMS Building Ripley, Mississippi McMaster & Associates, Inc. – M-2696-2

Plan Holders,

The following changes and clarifications are hereby made a part of and take precedence over conflicting sections of the Drawings and Specifications.

GENERAL INFORMATION AND CLARIFICATIONS:

- Item 1. The size of the fire line shall match F-100. C3.1 has been revised.
- Item 2. This is to facilitate the construction and function of the concrete flume for drainage. If this can be accomplished by only moving the guy wire, then this is acceptable. It is also acceptable to install a temporary guy wire for support during the installation of the concrete flume that could be removed once construction is complete.
- Item 7. Section 31-2323.33-Flowable Fill is to be used only if needed during the utility work and only if directed by the Engineer.
- Item 8. Section 31-3419-Geotextile Fabric is to be used beneath the proposed riprap and concrete flume.
- Item 9. Section 31-1129-Lime Treated Base Course is to be used only if needed to stabilize unsuitable soil and if directed by the Engineer and Geotechnical Consultant.
- Item 10. Section 31-4900-Storm Drainage Structures is to be used only if directed by the Engineer.

PERTAINING TO THE DRAWINGS:

Item 1. C3.1 has been revised.

END OF CIVL ITEMS FOR ADDENDUM NO. ONE (1)



REPLACEMENT FACILITY FOR TIPPAH COUNTY HOSPITAL EMS BUILDING


MECHANICAL ADDENDUM NO. 1 ITEMS:

Α

- 1. Sheet P100 Delete entire sheet and replace with attached. Changes made included the following:
 - a. Re-routed domestic hot water and domestic hot water return piping transition.
 - b. Added ball valves to domestic hot and domestic cold water piping in 'EMS Commons 100' area.
- 2. Sheet P200 Delete entire sheet and replace with attached. Changes made included the following:
 - a. Corrected WH-01 'Electrical Service' value on 'Domestic Water Heater Schedule'.
- 3. Sheet P300 Delete entire sheet and replace with attached. Changes made included the following:
 - a. Added details.
- 4. Sheet M300 Delete entire sheet and replace with attached. Changes made included the following:
 - a. Added Details.

END OF MECHANICAL ITEMS FOR ADDENDUM NO. 1

Jon D. Rice & Associates, LLC

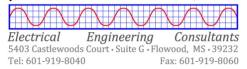

December 19, 2022

Dean Architecture 661 Sunnybrook, Ste 140 Ridgeland, MS 39157

Re: Tippah County Hospital

EMS Building Ripley, MS

Addendum #1 (Electrical)

Electrical addendum items are as follows:

Sheet E101:

- 1. There is an existing utility company power pole that cannot be relocated that has a guy wire that may interfere with construction of the concrete flume for drainage. If required, provide a new guy wire so that the original guy wire can be temporarily removed to pour concrete. Once concrete work is complete, re-install original guy wire. Coordinate work with Utility Company.
- 2. A post indicator valve for the fire alarm system is shown.


Sheet E201:

1. The Fire Suppression System Riser Bell has been relocated to the southeast corner of the building.


End of Addendum

Thank you,

Michael Layman

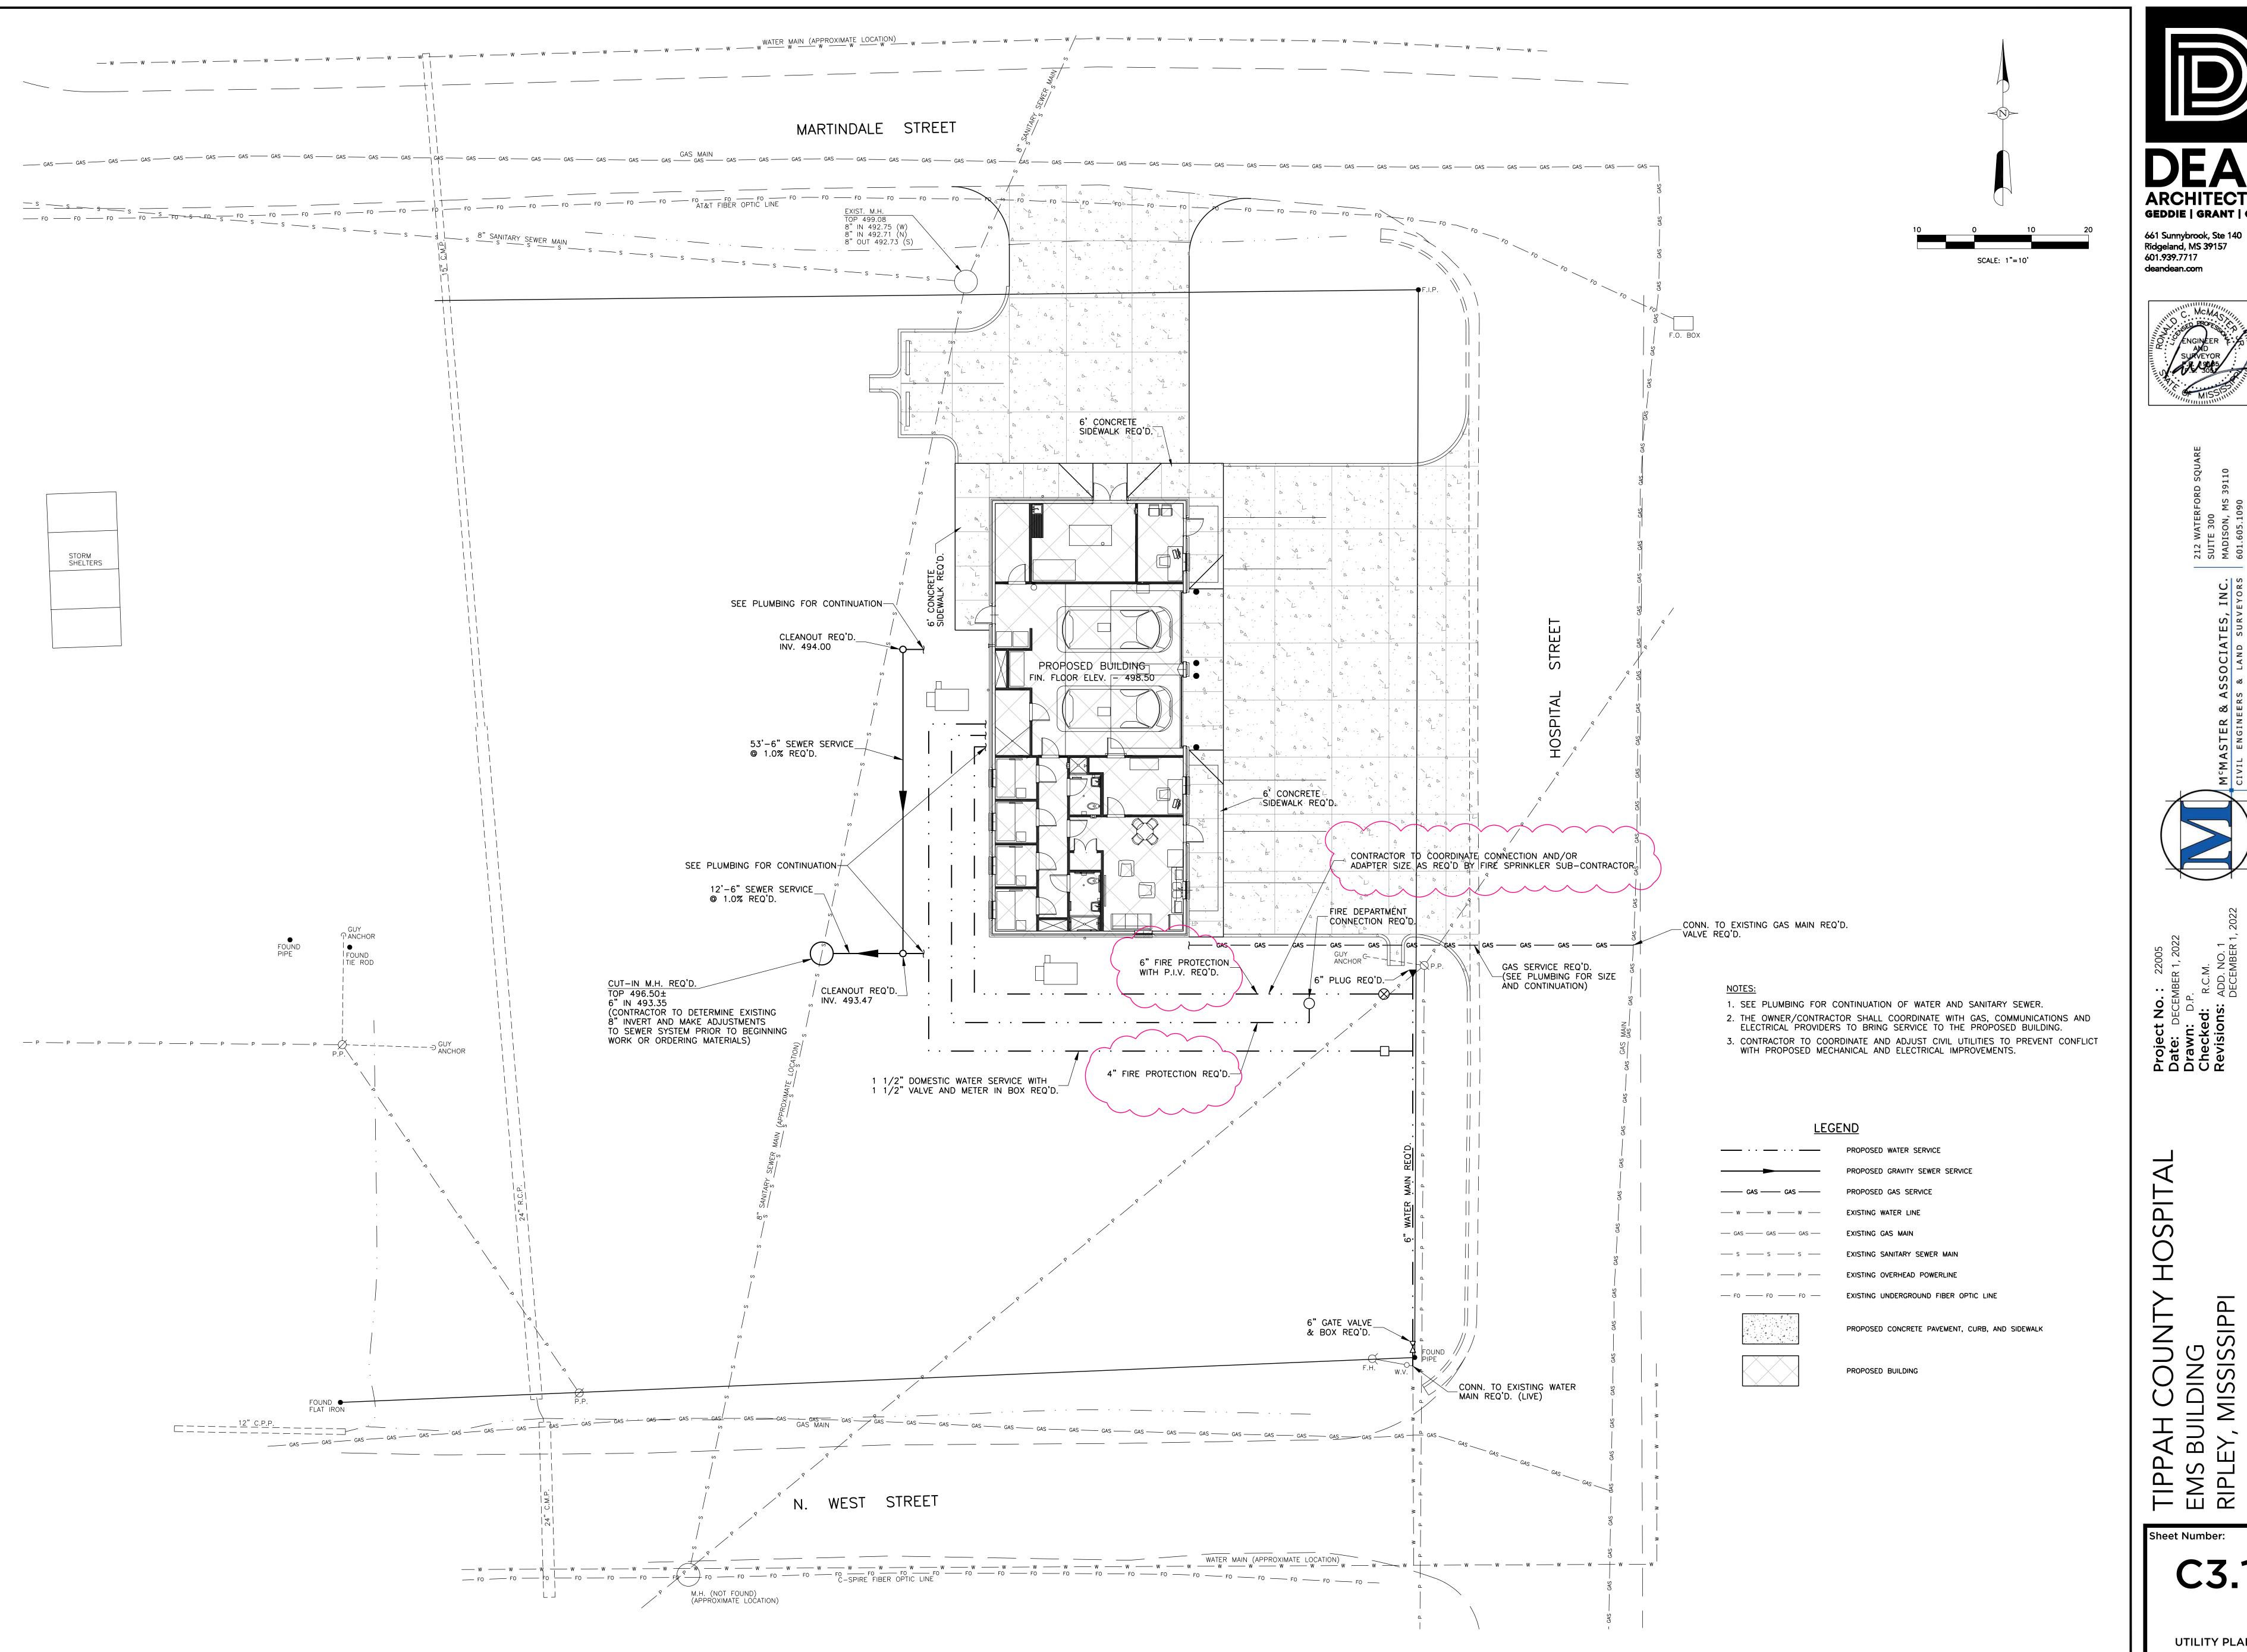




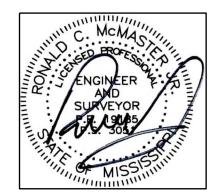

AH (
BUILE

Sheet Number:

UTILITY PLAN

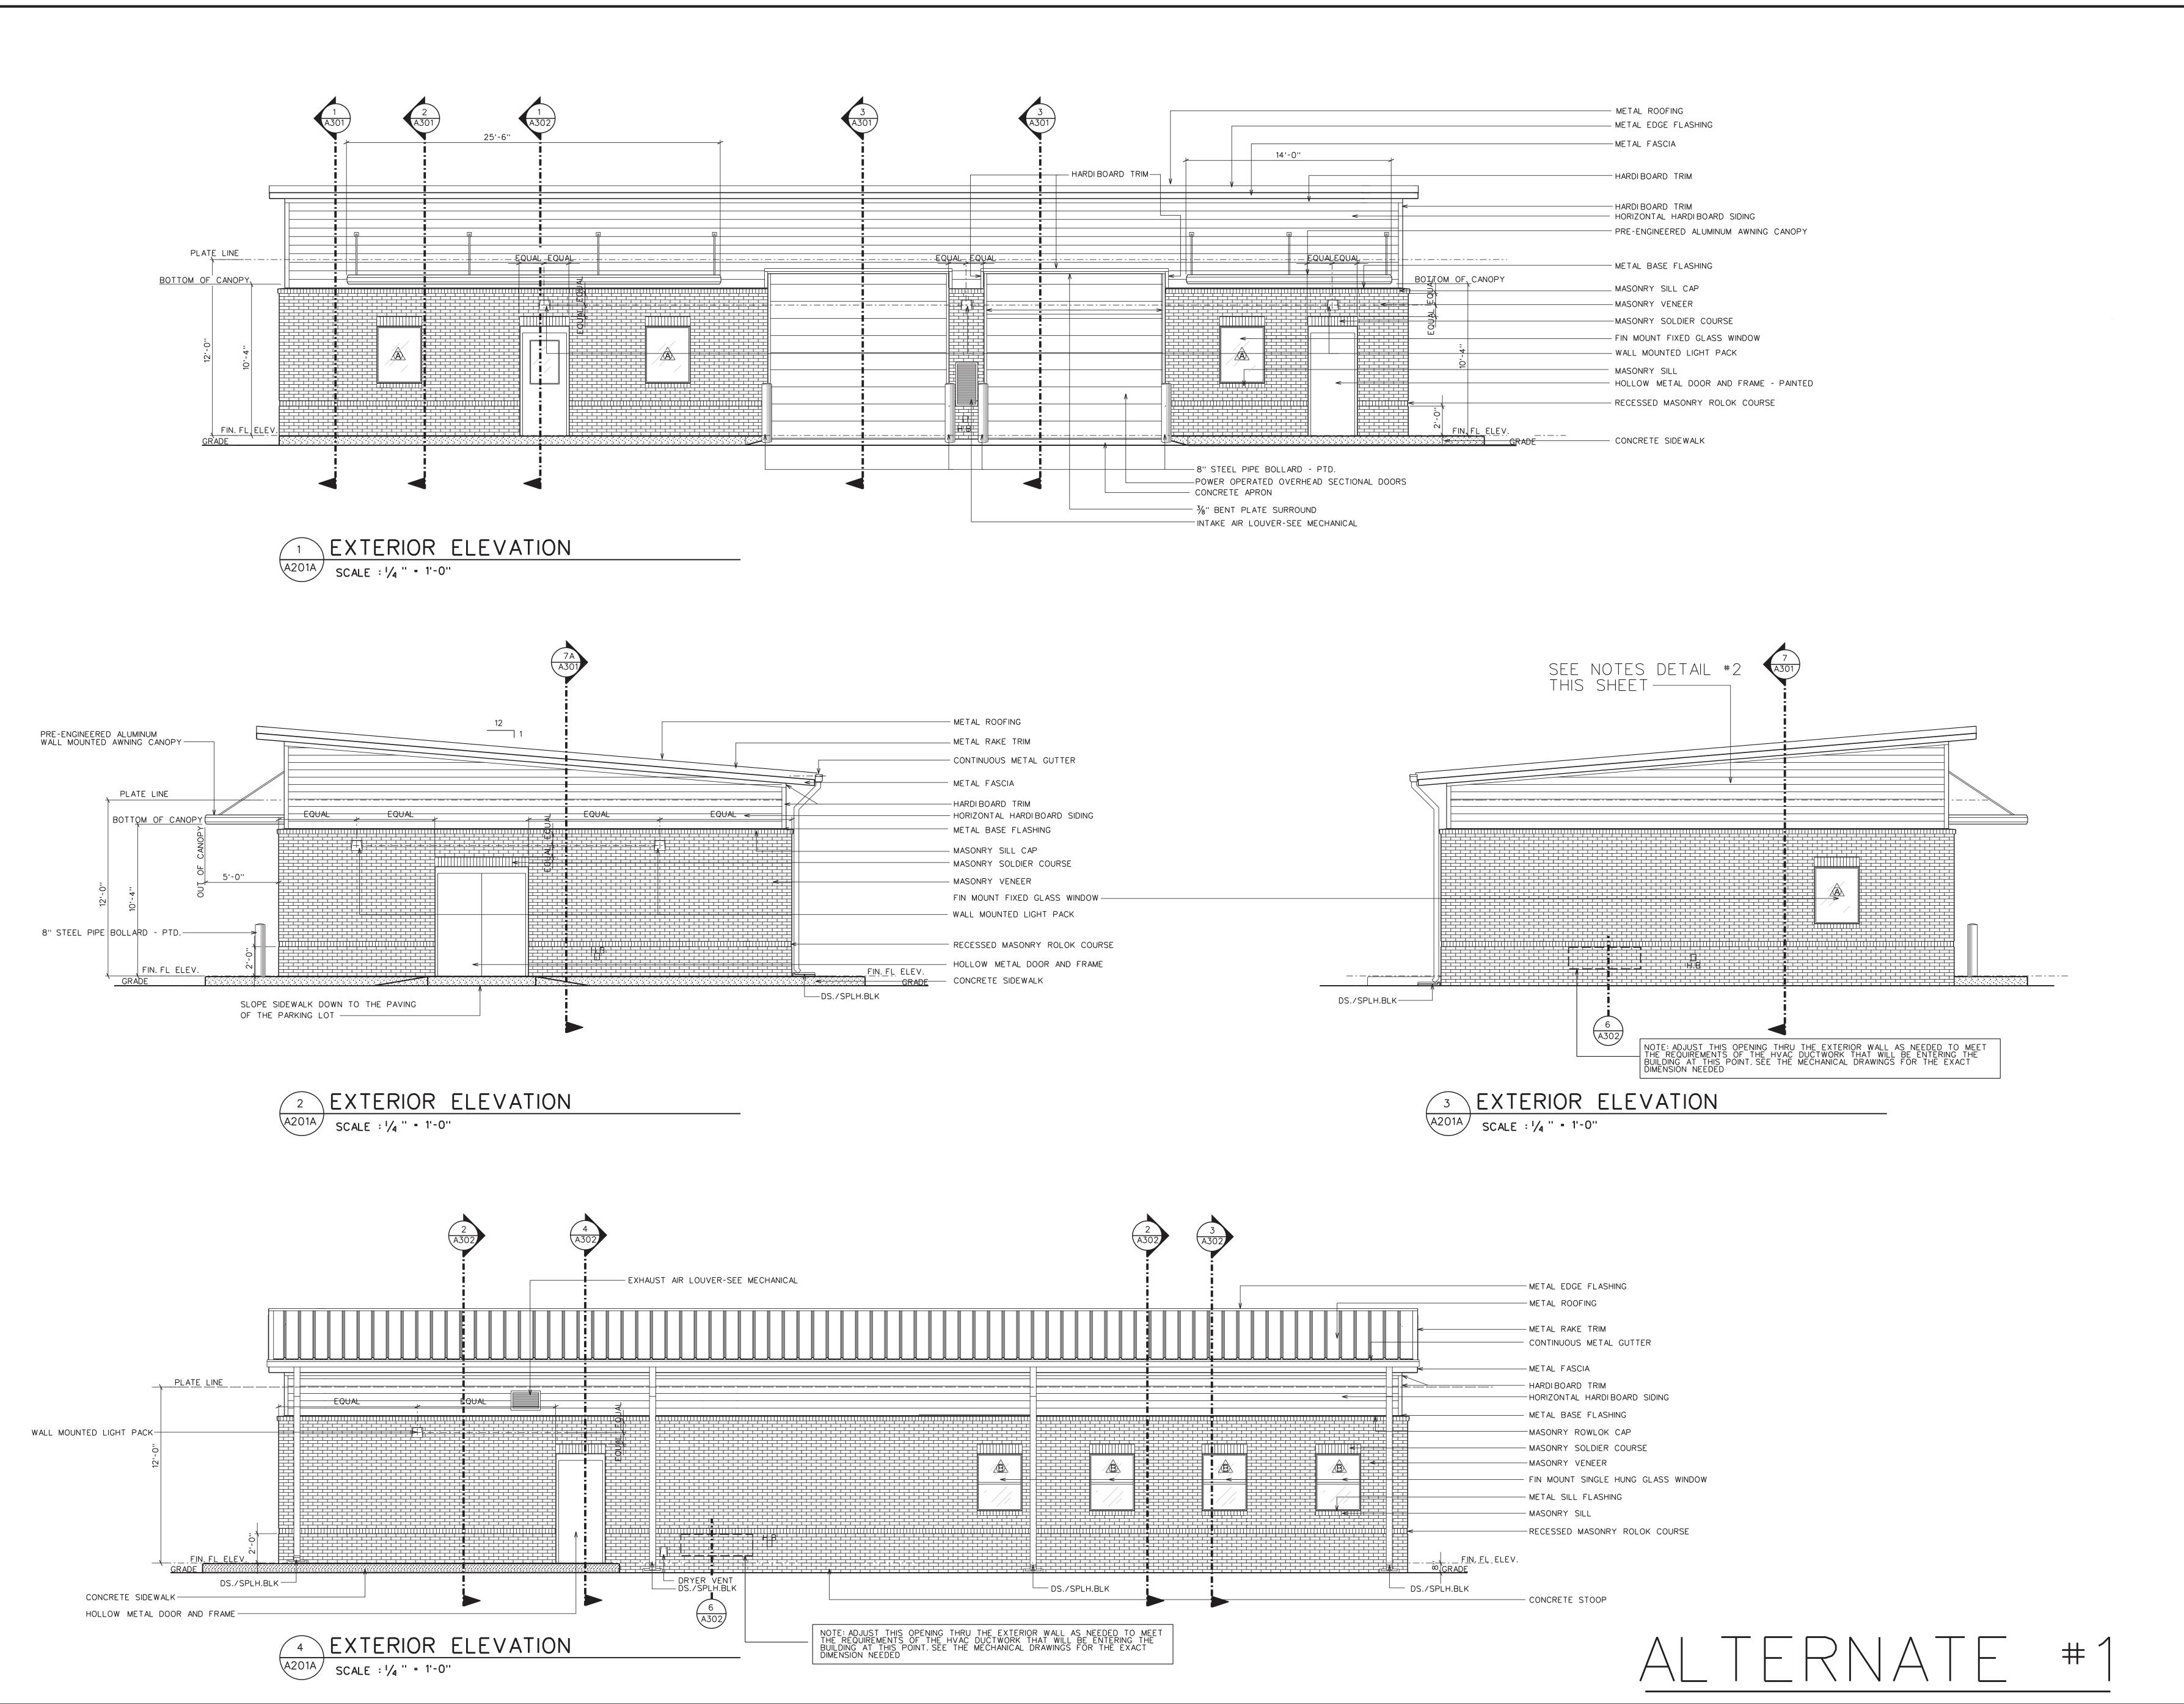

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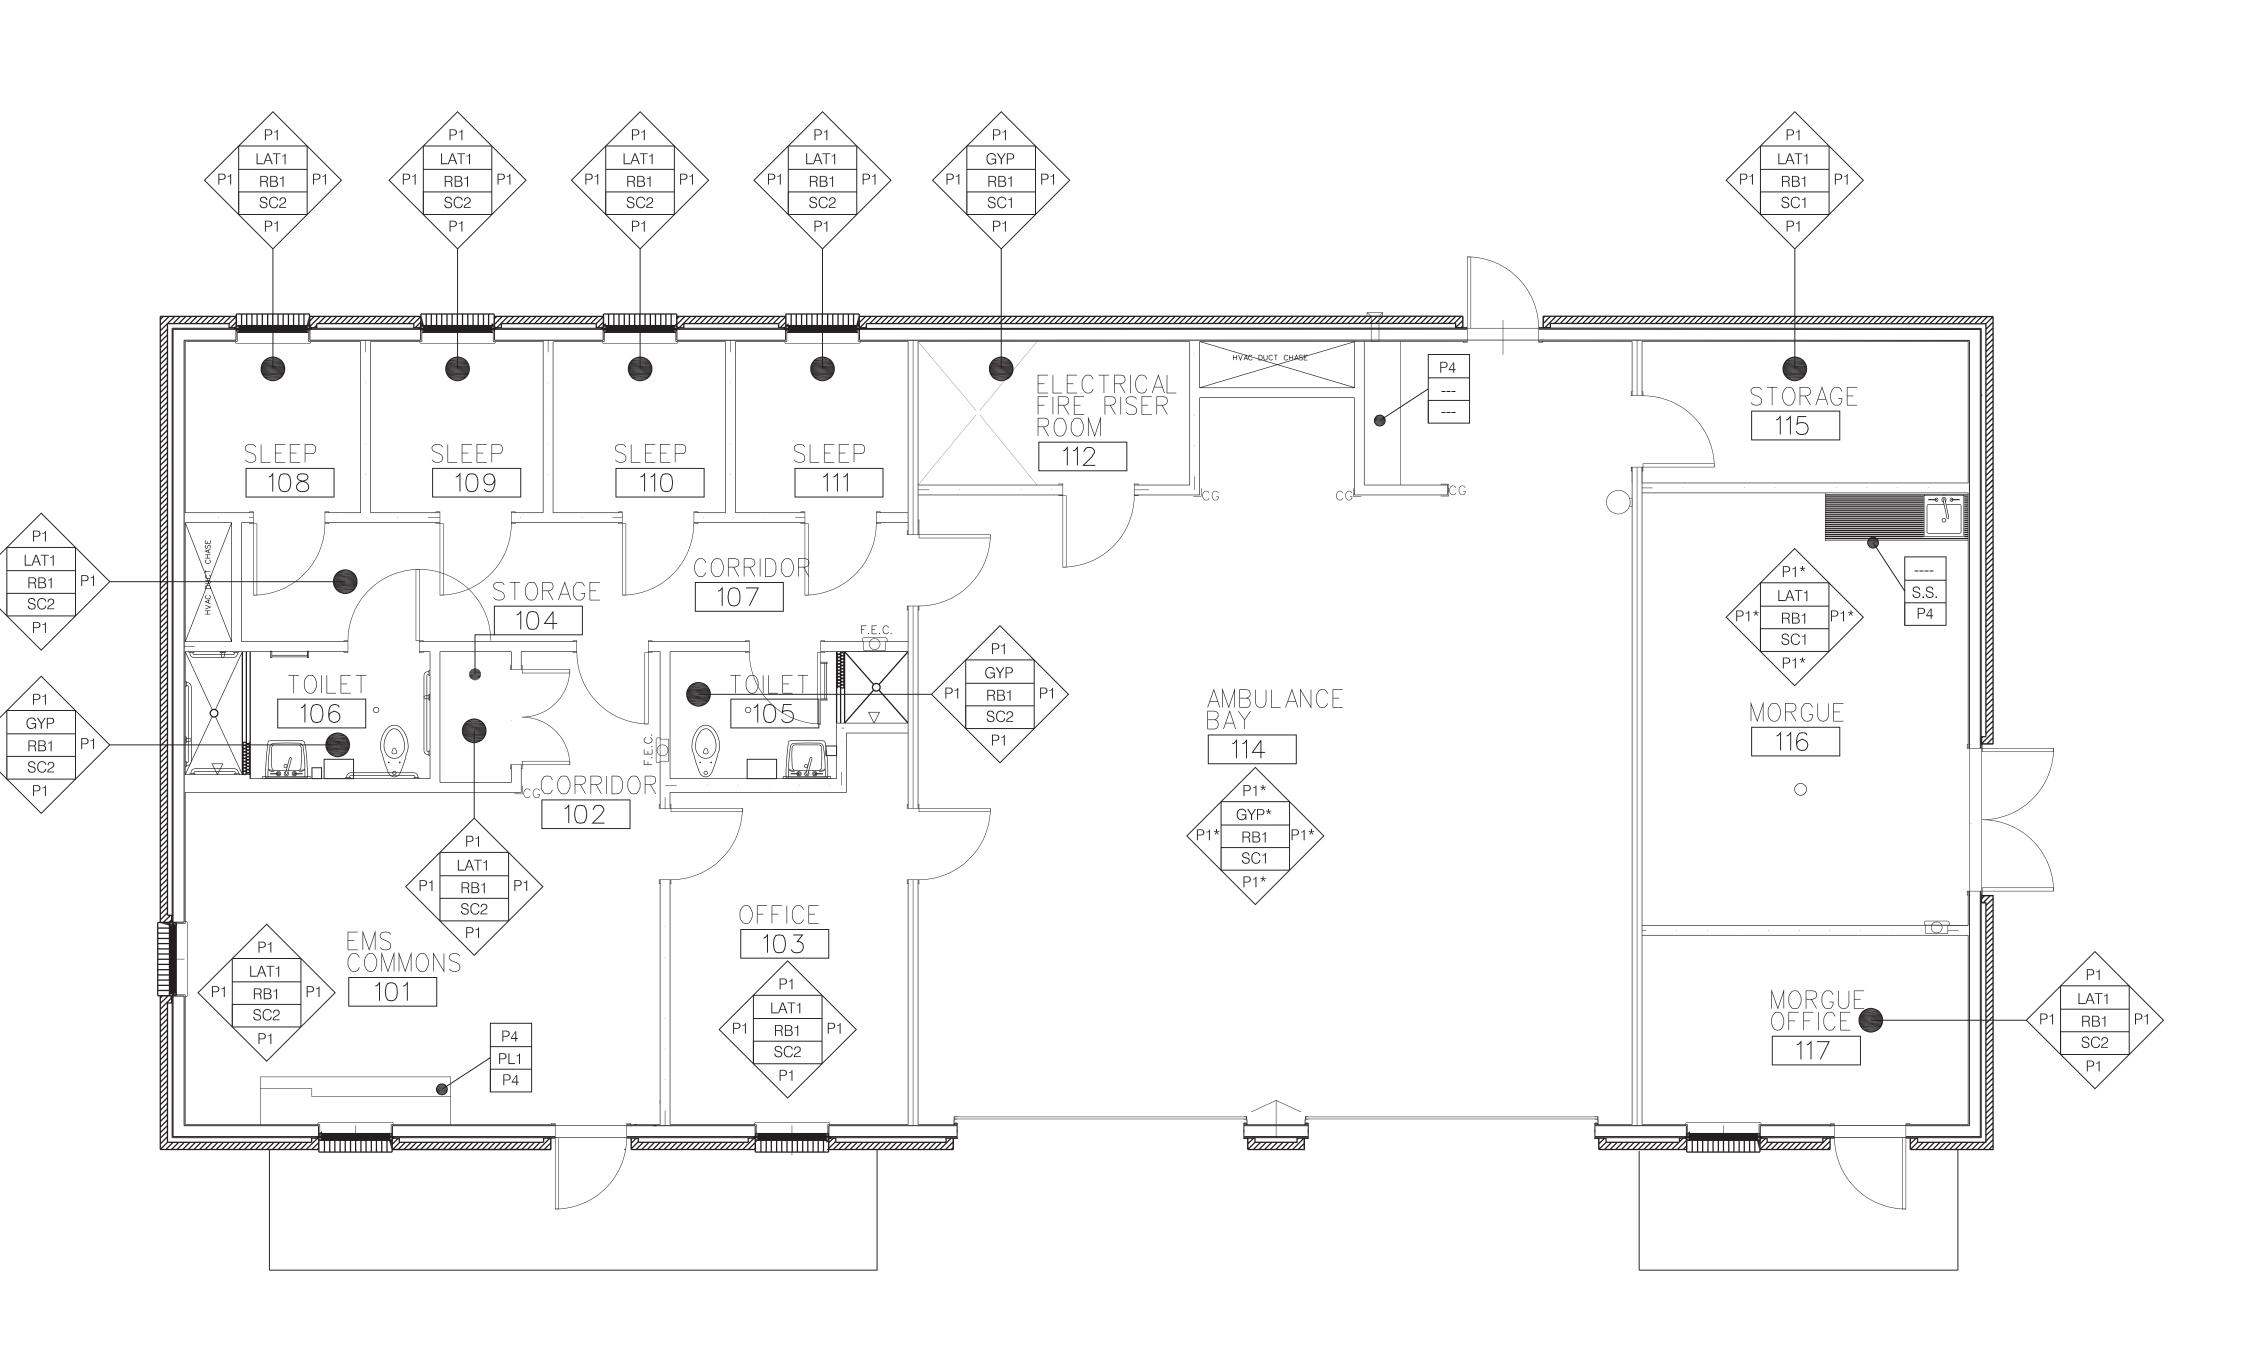
ARCHITECTURE GEDDIE | GRANT | OUBRE 661 Sunnybrook, Ste 140 Ridgeland, MS 39157 601.939.7717



deandean.com

3

Sheet Number:









Drawn: FBH, MP
Checked: KAO
Revisions: ADDENDUM #1 DECEMBER 19, 203
REPLACE SHEET IN ENTIRETY

HOSPITAL

EMS BUILDING

Sheet Number:

LEGEND - PLUMBING


MARK	DESCRIPTION
W	NEW SITE WATER SERVICE PIPING
MPG	NEW MEDIUM PRESSURE GAS PIPING
GSP	NEW GAS SERVICE PIPING (BY SERVING UTILITY)
——————————————————————————————————————	NEW LOW PRESSURE GAS PIPING
ss	NEW SANITARY WASTE PIPING
PCW	NEW POTABLE COLD WATER PIPING
PHW	NEW POTABLE HOT WATER PIPING (120°F)
PHWR	NEW POTABLE RECIRCULATING HOT WATER PIPING (120°F)
D	NEW CONDENSATE DRAIN PIPING
	FULL PORT BALL VALVE (LEAD FREE)
	CIRCUIT SETTER TYPE MANUAL BALANCING VALVE
	GAS COCK
	TYPICAL FINISHED GRADE CLEANOUT
•	TYPICAL NATURAL GAS REGULATOR AND/OR METER
○ + HB	HOSE BIBB
← WCO	WALL CLEANOUT
	WATER HAMMER ARRESTOR
•	TYPICAL NEW DEEP SHUTOFF VALVE IN TELESCOPIC CAST IRON VALVE BOX WITH COVER LABELED "WATER"
FD	FLOOR DRAIN
HW	HOT WATER
CW	COLD WATER
W	WASTE
V	VENT
A/C	ABOVE CEILING
B/S	BELOW SLAB
B/F	BELOW FLOOR
A/G	ABOVE FINISHED GRADE
B/G	BELOW FINISHED GRADE
I/W	IN WALL
DN.	DOWN
FFCO	FINISHED FLOOR CLEANOUT
FGCO	FINISHED GRADE CLEANOUT
VTR	VENT THRU ROOF
AFF	ABOVE FINISHED FLOOR
CO	CLEANOUT


GENERAL PLUMBING NOTES:


1. PROVIDE ALL PLUMBING PIPING, FIXTURES, TRIM, AND ACCESSORIES AS REQUIRED FOR A COMPLETE AND FUNCTIONAL PLUMBING SYSTEM. VERIFY WITH ARCHITECT AND DRAWINGS, WHICH PLUMBING INSTALLATIONS ARE DESIGNATED FOR ADA ACCESSIBILITY. ALL SUCH FIXTURE INSTALLATIONS SHALL INCLUDE ALL INSTALLATION ACCESSORIES, MOUNTING/LIP HEIGHT, CONTROL OFFSET, SIZE AND ACCESSIBILITY AS REQUIRED BY LATEST EDITION OF AMERICANS WITH DISABILITIES ACT (ADA) AND LOCAL

WALL CLEANOUT


- 2. ALL PLUMBING VENTS, WHERE NOTED VENT UP (V. UP), SHALL BE COMBINED WITHIN WALL OR ABOVE CEILING CONCEALED AREAS, WHERE FEASIBLE, SO AS TO MINIMIZE ROOF PENETRATIONS. COORDINATE LOCATION OF ROOF PLUMBING AND FLUE VENTS SUCH THAT ALL VENTS ARE MINIMUM 15 FEET FROM ANY VENTILATION INTAKE DEVICES. ALL ROOF PENETRATIONS, VENTS, FLUES, ETC., SHALL BE MADE ON BACK SIDE OF ROOF AS CAN BE COORDINATED WITH ARCHITECT. ALL FLUES AND VENTS EXPOSED ABOVE ROOF SHALL BE FIELD PAINTED COLOR BY ARCHITECT.
- 3. ALL PIPING SHALL BE CONCEALED INSIDE WALLS AND PIPE CHASES OR ABOVE CEILINGS, EXCEPT AS OTHERWISE NOTED AND AT APPROPRIATE EQUIPMENT FINAL CONNECTIONS. HOLD ALL PIPING ABOVE CEILINGS AS HIGH AS POSSIBLE AND COORDINATE WITH OTHER CRAFTS.
- 4. COORDINATE ALL WORK WITH ARCHITECTURAL, STRUCTURAL, MECHANICAL, AND ELECTRICAL TRADES. PIPE ROUTING SHOWN IS DIAGRAMMATIC. PROVIDE ALL OFFSETS, ETC., TO AVOID INTERFERENCES WITH STRUCTURAL MEMBERS, EQUIPMENT, PIPING, DUCTWORK, LIGHTS, CONDUIT, ETC.
- 5. VERIFY/COORDINATE PIPE SIZES AND CONNECTIONS WITH "PLUMBING FIXTURE ROUGH-IN SCHEDULE" FOR WASTE, VENT AND WATER PIPING ROUGH-IN SIZES NOT CLEARLY SHOWN ON PLANS OR IN RISER DIAGRAMS, ETC. CONTACT PROFESSIONAL SHOULD QUESTIONS OR CONFLICTS ARISE. PROVIDE ROUGH-IN, FINAL CONNECTIONS AND INSTALLATION APPURTENANCES AS RECOMMENDED BY APPLIANCE AND/OR EQUIPMENT MANUFACTURER FOR DISHWASHERS, ICE MAKERS, AND MACHINES, WASHERS, DRYERS, ETC. VERIFY LOCATION ON ARCHITECTURAL DRAWINGS AND CONNECTION REQUIREMENTS FROM APPROVED BROCHURES OF THE EQUIPMENT AND/OR APPLIANCES MANUFACTURER.
- 6. COORDINATE SLOPE OF ALL DRAINAGE AND VENT PIPING BELOW GRADE AT INVERT ELEVATIONS INDICATED. CONSISTENTLY SLOPE ALL OTHER PIPING, NOT INDICATED, AS REQUIRED BY PLUMBING CODE APPLICABLE TO THIS PROJECT BUT IN NO CASE LESS THAN 1%.
- 7. ALL VERTICAL RISERS TO FLOOR DRAINS AND FLOOR MOUNTED SINKS SHALL BE MAXIMUM 24" LONG.
- 8. ALL ABOVE GRADE HORIZONTAL DRAINAGE AND VENT PIPING ROUTING SHALL BE COORDINATED WITH OTHER CRAFTS AND STRUCTURAL/ARCHITECTURAL DRAWINGS. CONSISTENTLY SLOPE ALL PIPING, NOT INDICATED WITH ELEVATIONS, AS REQUIRED BY PLUMBING CODE APPLICABLE TO THIS PROJECT BUT IN NO CASE LESS THAN 1%.
- 9. WHEN SLEEVES, PIPES, CONDUITS, ETC. PENETRATE GRADE BEAMS OR TIE BEAMS, INCREASE THE DEPTH OF THE PENETRATED BEAM BY NO LESS THAN TWICE THE DIAMETER OF THE PENETRATION FOR A DISTANCE OF 4'-0" CENTERED ON THE PENETRATION. WHERE THE PENETRATION INTERRUPTS REINFORCING STEEL, AN EQUAL NUMBER OF LIKE SIZE REINFORCING BARS SHALL BE BENT UNDER THE PENETRATION AND LAP SPLICED 30 BAR DIAMETERS ON EACH SIDE. CONCRETE COVER REQUIREMENTS ON ALL SIDES SHALL BE THE SAME AS SHOWN FOR THE UN-MODIFIED GRADE BEAM OR TIE BEAM. SEE STRUCTURAL DRAWINGS FOR FURTHER SPECIFICS, ETC. PROVIDE NEW SCHEDULE 40 PVC PIPE SLEEVE A MIN. TWO SIZES LARGER THAN CARRIER PIPE AT ALL SUCH CROSSINGS, TO EXTEND MIN. 6" PAST FOUNDATION ON BOTH ENDS. PROVIDE OAKUM AND SEALANT IN ANNULAR SPACE OF SLEEVES AND WATER PROOF ON ALL BUILDING PERIMETER AND INTERIOR FOOTING AND GRADE BEAM APPLICATIONS.
- 10. ALL CLEANOUTS IN SANITARY, STORM AND CONDENSATE DRAIN PIPING SHALL BE FULL PIPE SIZE UP TO 4" AND SHALL BE 4" SIZE ON 6" AND LARGER PIPING.

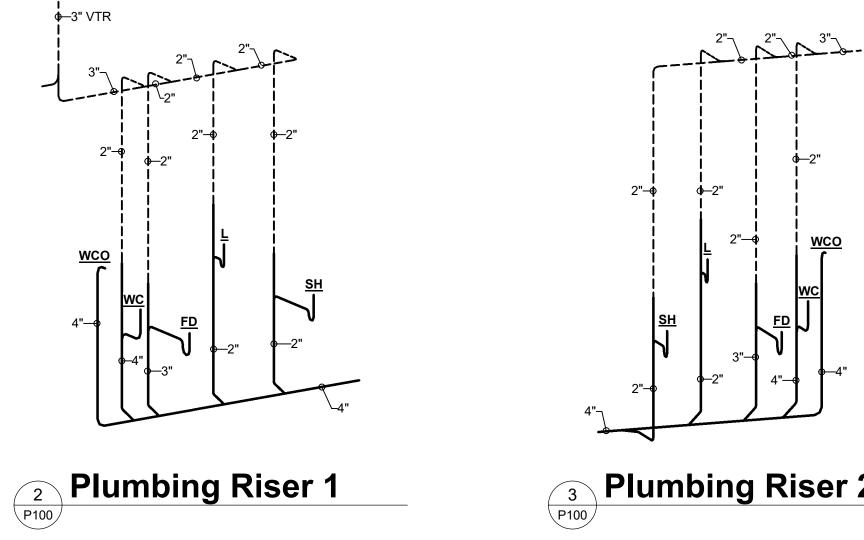

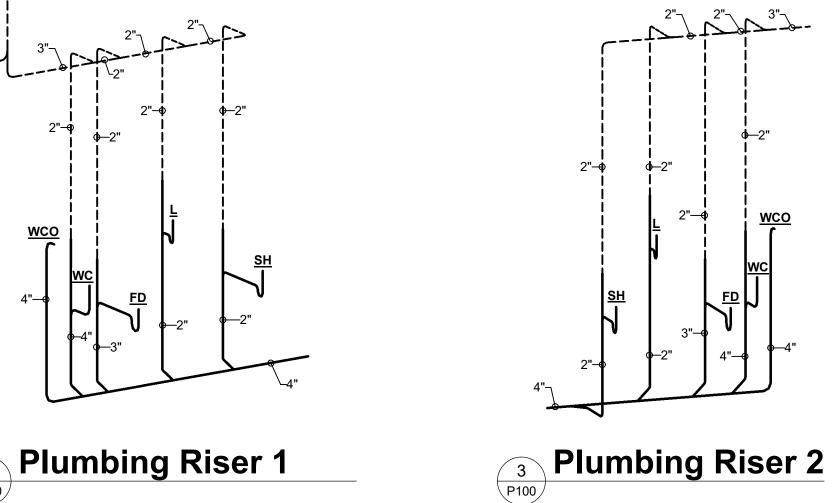

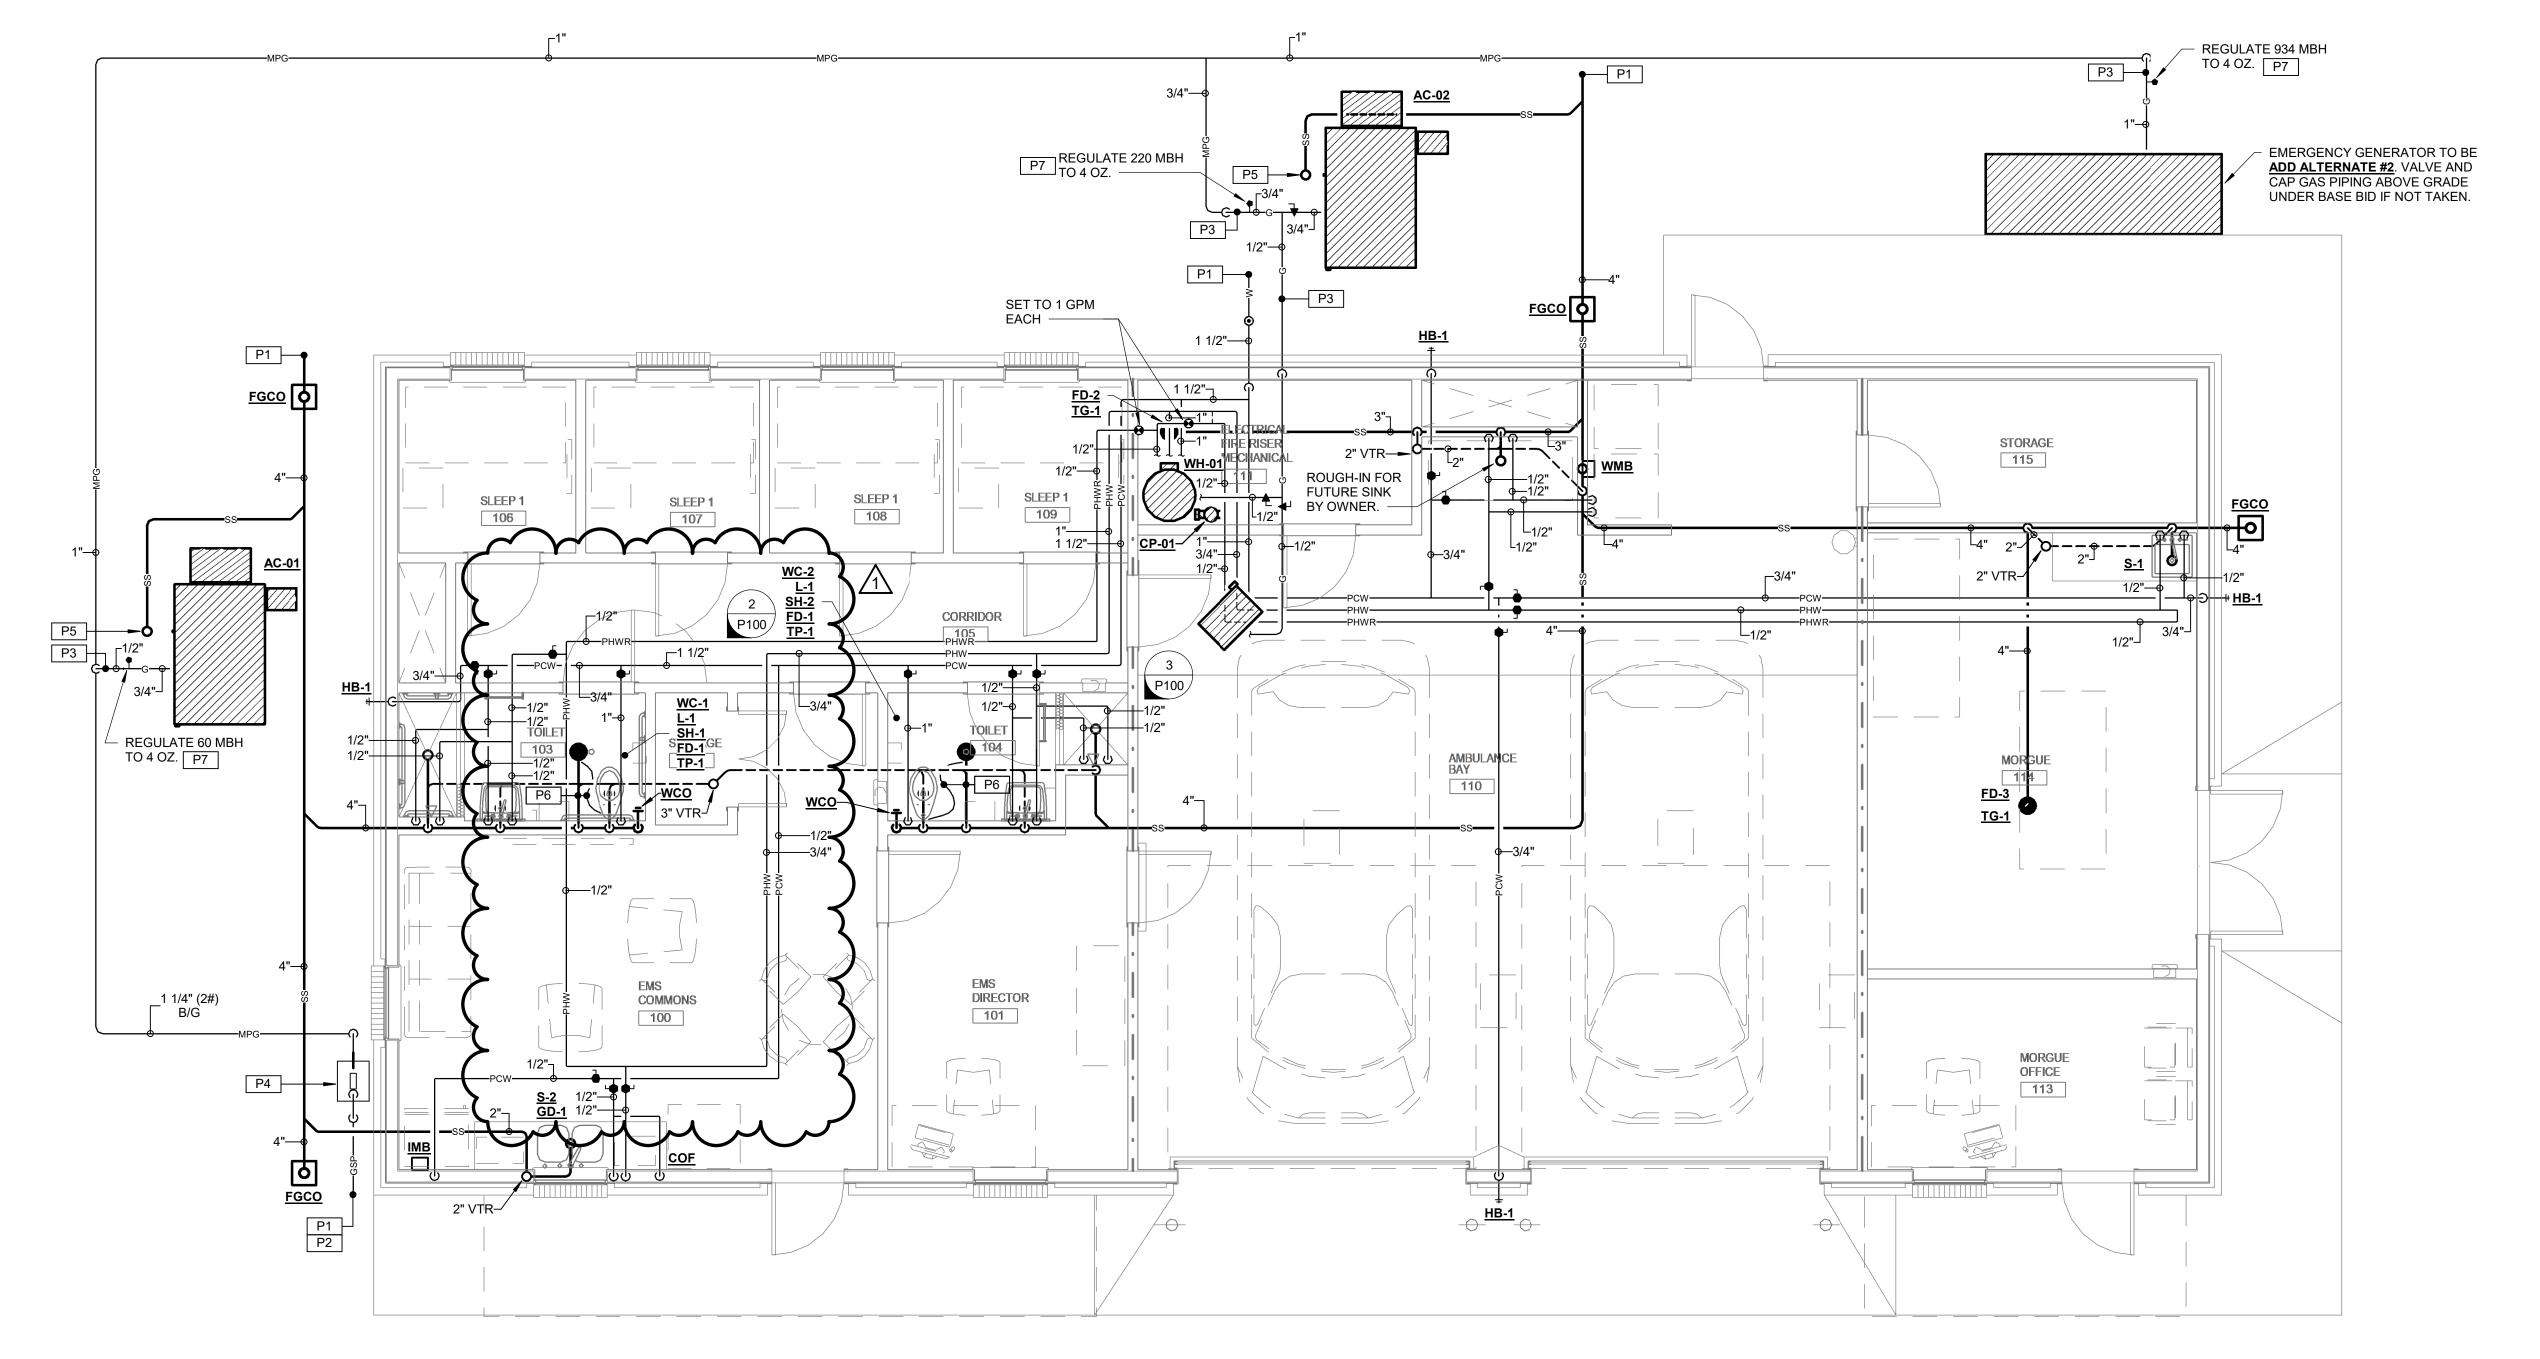



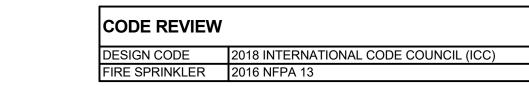

DRAWING INDEX - PLUMBING									
Sheet Number	nber Sheet Name								
P100	Overall Plumbing Plan								
P200	Plumbing Schedules								
P300	Plumbing Details								

SPECIFIC PLUMBING NOTES										
P1	TYPICAL SERVICE PIPING BELOW GRADE. SEE CIVIL DRAWINGS FOR CONTINUATION.									
P2	TYPICAL NEW GAS SERVICE PIPING ROUTED BELOW GRADE. VERIFY/COORDINATE WITH LOCAL SERVING UTILITY COMPANY. ALL COST AND COORDINATION SHALL BE INCLUDED.									
P3	ROUTE NEW GAS PIPING ATOP UNISTRUT SUPPORTS ATOP NEW EQUIPMENT CONCRETE PAD.									
P4	GAS METER PROVIDED BY SERVING UTILITY COMPANY. COST AND COORDINATION SHALL BE INCLUDED. REGULATE 1250 CFH TO 2 LBS.									
P5	TYPICAL 4" TRAPPED HUB DRAIN FOR PAD MOUNTED PACKAGE UNIT CONDENSATE DRAIN. SEE DETAIL FOR CLARITY.									
P6	1/2" TYPE 'K' SOFT COPPER TRAP PRIMER AND 3" WASTE BELOW SLAB/FLOOR.									
P7	PROVIDE GAS REGULATOR (SEE DETAIL). SEE DRAWINGS FOR CAPACITY. PROVIDE VENTLESS REGULATOR OR EXTEND VENT AWAY FROM O/A INTAKE ON HVAC UNITS WHERE APPLICABLE.									



Ridgeland, MS 39157 601.939.7717



Consulting Engineering 201 Park Court - Suite A | Ridgeland, MS 39157 P: 601.605.2930 F: 844.493.3111 www.gskmech.com



OTOR STARTER SCHEDULE											
SERVING	HP OF EACH LOAD	ELECTRICAL CHARACTERISTICS	BASIS OF DESIGN	NOTES [1]							
P-01	1/12	120V.,1ph	FRANKLIN CONTROLS SYSTMS MODEL BAS-1P								

- [1] NOTES1. SEE CONTROL SEQUENCE FOR ADDITIONAL CONTROL REQUIREMENTS.2. MOUNT STARTER WITHIN 10' OF EQUIPMENT SERVED. COORDINATE IN FIELD SPECIFIC LOCATION.
- B. COMBINATION MOTOR STARTER/DISCONNECT.

DOMESTIC WATER HEATER SCHEDULE

MARK	FUEL	STORAGE CAP., GAL.	RECOVERY G.P.H. AT 100 °F RISE	MAX. GPM	INPUT KW	INPUT MBH	ELECTRICAL SERVICE	BASIS OF DESIGN	FEATURES/ACCESSORIES
WH-01	N. GAS	50	115		\.\.\.\.\.\.\.\.\.\.\.\.\.\.\.\.\.\.\.	100.0	120V.,1ph	A.O. SMITH MODEL BTXL-100	1,2

FEATURES/ACCESSORIES:

PROVIDE PIPING, VALVES AND ACCESSORIES PER DETAILS.
 PROVIDE RECIRCULATING PUMP AND PIPING PER DETAIL.

VIBRATION ISOLATION / SEISMIC RESTRAINT SCHEDULE

SYSTEM/COMPONENT	SEISMIC DESIGN CATEGORY	SEISMIC COMPONENT IMPORTANCE FACTOR	BASIS OF DESIGN	REMARKS [1]
WATER HEATERS	D	1.0	VIBRO ACOUSTICS	1, 2, 3, 4
IN-LINE CIRCULATING PUMPS	D	1.0	VIBRO ACOUSTICS	1, 2, 3, 4
MISCELLANEOUS WALL MOUNTED/SUSPENDED PLUMBING EQUIPMENT	D	1.0	VIBRO ACOUSTICS	1, 2, 3, 4
MISCELLANEOUS FLOOR/ROOF MOUNTED PLUMBING EQUIPMENT	D	1.0	VIBRO ACOUSTICS	1, 2, 3, 4
NATURAL GAS PIPING	D	1.5	VIBRO ACOUSTICS	1, 2, 3, 4
REFRIGERANT PIPING	D	1.5	VIBRO ACOUSTICS	1, 2, 3, 4
DOMESTIC COLD WATER PIPING	D	1.0	VIBRO ACOUSTICS	1, 2, 3, 4
DOMESTIC HOT AND RECIRCULATING WATER PIPING	D	1.0	VIBRO ACOUSTICS	1, 2, 3, 4
SANITARY WASTE AND VENT PIPING (ABOVE SLAB)	D	1.0	VIBRO ACOUSTICS	1, 2, 3, 4
·				

[1] <u>REMARKS:</u>

- SEE SPECIFICATIONS FOR ADDITIONAL REQUIREMENTS
 SEISMICALLY RATED FOR PROJECT CONDITIONS
 SEE STRUCTURAL DRAWINGS FOR MORE INFORMATION
 SEE SPECIFICATIONS FOR PIPING MATERIALS IN EACH APPLICATION

PLUMBING FIXTURE SCHEDULE

	MADIC	ADA	DESCRIPTION		ROUGH-IN REQUIREMENTS						
	MARK	REQ'D	DESCRIPTION	WASTE	VENT	120 °F HW	CW	TEMPERED	CARRIER REQ'		
7	WC-1	YES	WATER CLOSET - FLOOR MOUNTED FLUSH VALVE	4"	2"-4"	-	1"	-	NO		
1	WC-2	NO	WATER CLOSET - FLOOR MOUNTED FLUSH VALVE	4"	2"-4"	-	1"	-	NO		
	L-1	YES	LAVATORY - WALL MOUNTED TYPE (LOW PROFILE DUAL TEMP)	2"	2''	1/2''	1/2''	1/2''	YES		
	S-1	NO	SINK - SINGLE COMPARTMENT, STAINLESS STEEL, SELF-RIMMING (20x19Wx10)	2"	2"	1/2''	1/2"	-	NO		
	S-2	NO	SINK - DOUBLE COMPARTMENT, STAINLESS STEEL, SELF-RIMMING (22x33Wx8)	2"	2"	1/2"	1/2"	-	NO		
	SH-1	YES	SHOWER ENCLOSURE AND FITTINGS	2"	2"	1/2"	1/2"	-	NO		
	SH-2	NO	SHOWER ENCLOSURE AND FITTINGS	2"	2"	1/2"	1/2"	-	NO		
.]	HB-1	NO	HOSE BIBB - NON-FREEZE TYPE IN LOCKING BOX	-	-	-	3/4''	-	NO		
4	TP-1	NO	TRAP PRIMER - CONNECT TO FLUSH VALVE ASSEMBLY	-	-	-	1/2"	-	NO		
4	TG-1	NO	TRAP GUARD	-	-	-	-	-	NO		
-	WMB	NO	WASHING MACHINE BOX WITH BRAIDED STAINLESS STEEL HOSES	2''	2''	1/2"	1/2"	-	NO		
1	IMB	NO	ICE MAKER WITH TYPE "K" COPPER WATER LINE	-	-	-	1/2"	-	NO		
	FD-1	NO	FLOOR DRAIN - GENERAL DRAINAGE IN TOILET AREAS	3"	2''	-	-	-	NO		
	FD-2	NO	FLOOR DRAIN - AREA MECHANICAL ROOM DRAINAGE	4"	2''	-	-	-	NO		
	FD-3	NO	FLOOR DRAIN - MORGUE	4"	2''	-	-	-	NO		
	COF	NO	COFFEE MAKER CONNECTIONS	-	-	-	1/4"	-	NO		
1	GD-1	NO	GARBAGE DISPOSAL	2"	-	-	-	-	NO		
1											

CIRCULATING PUMP SCHEDULE

	LOCATION	[1]	CIRCULATING FLUIDS					NPSHR		[2]	ELECTRICAL DATA			
MARK		SYSTEM	FLUID	GPM	PUMP HEAD FT. FLUID	TEMP., °F	SP. GR.	(FEET)	% EFF.	TYPE	NOM. HP	SERVICE	RPM	BASIS OF DESIGN
CP-01	MECH ROOM	Α	WATER	2	20	60-200	1	10	-	Α	1/12	120V,.1ph	2650	BELL & GOSSETT MODEL PL-30B
	[1] SYSTEM A. DOMESTIC HOT WATER RECIRCULATING [2] TYPE A. INLINE - LOW LEAD BRONZE OR STAINLESS STEEL										COMPARABLE PRODUCTS: BELL AND GOSSETT, PACO, TACO			

COMPARABLE PRODUCTS:
BELL AND GOSSETT, PACO, TACO

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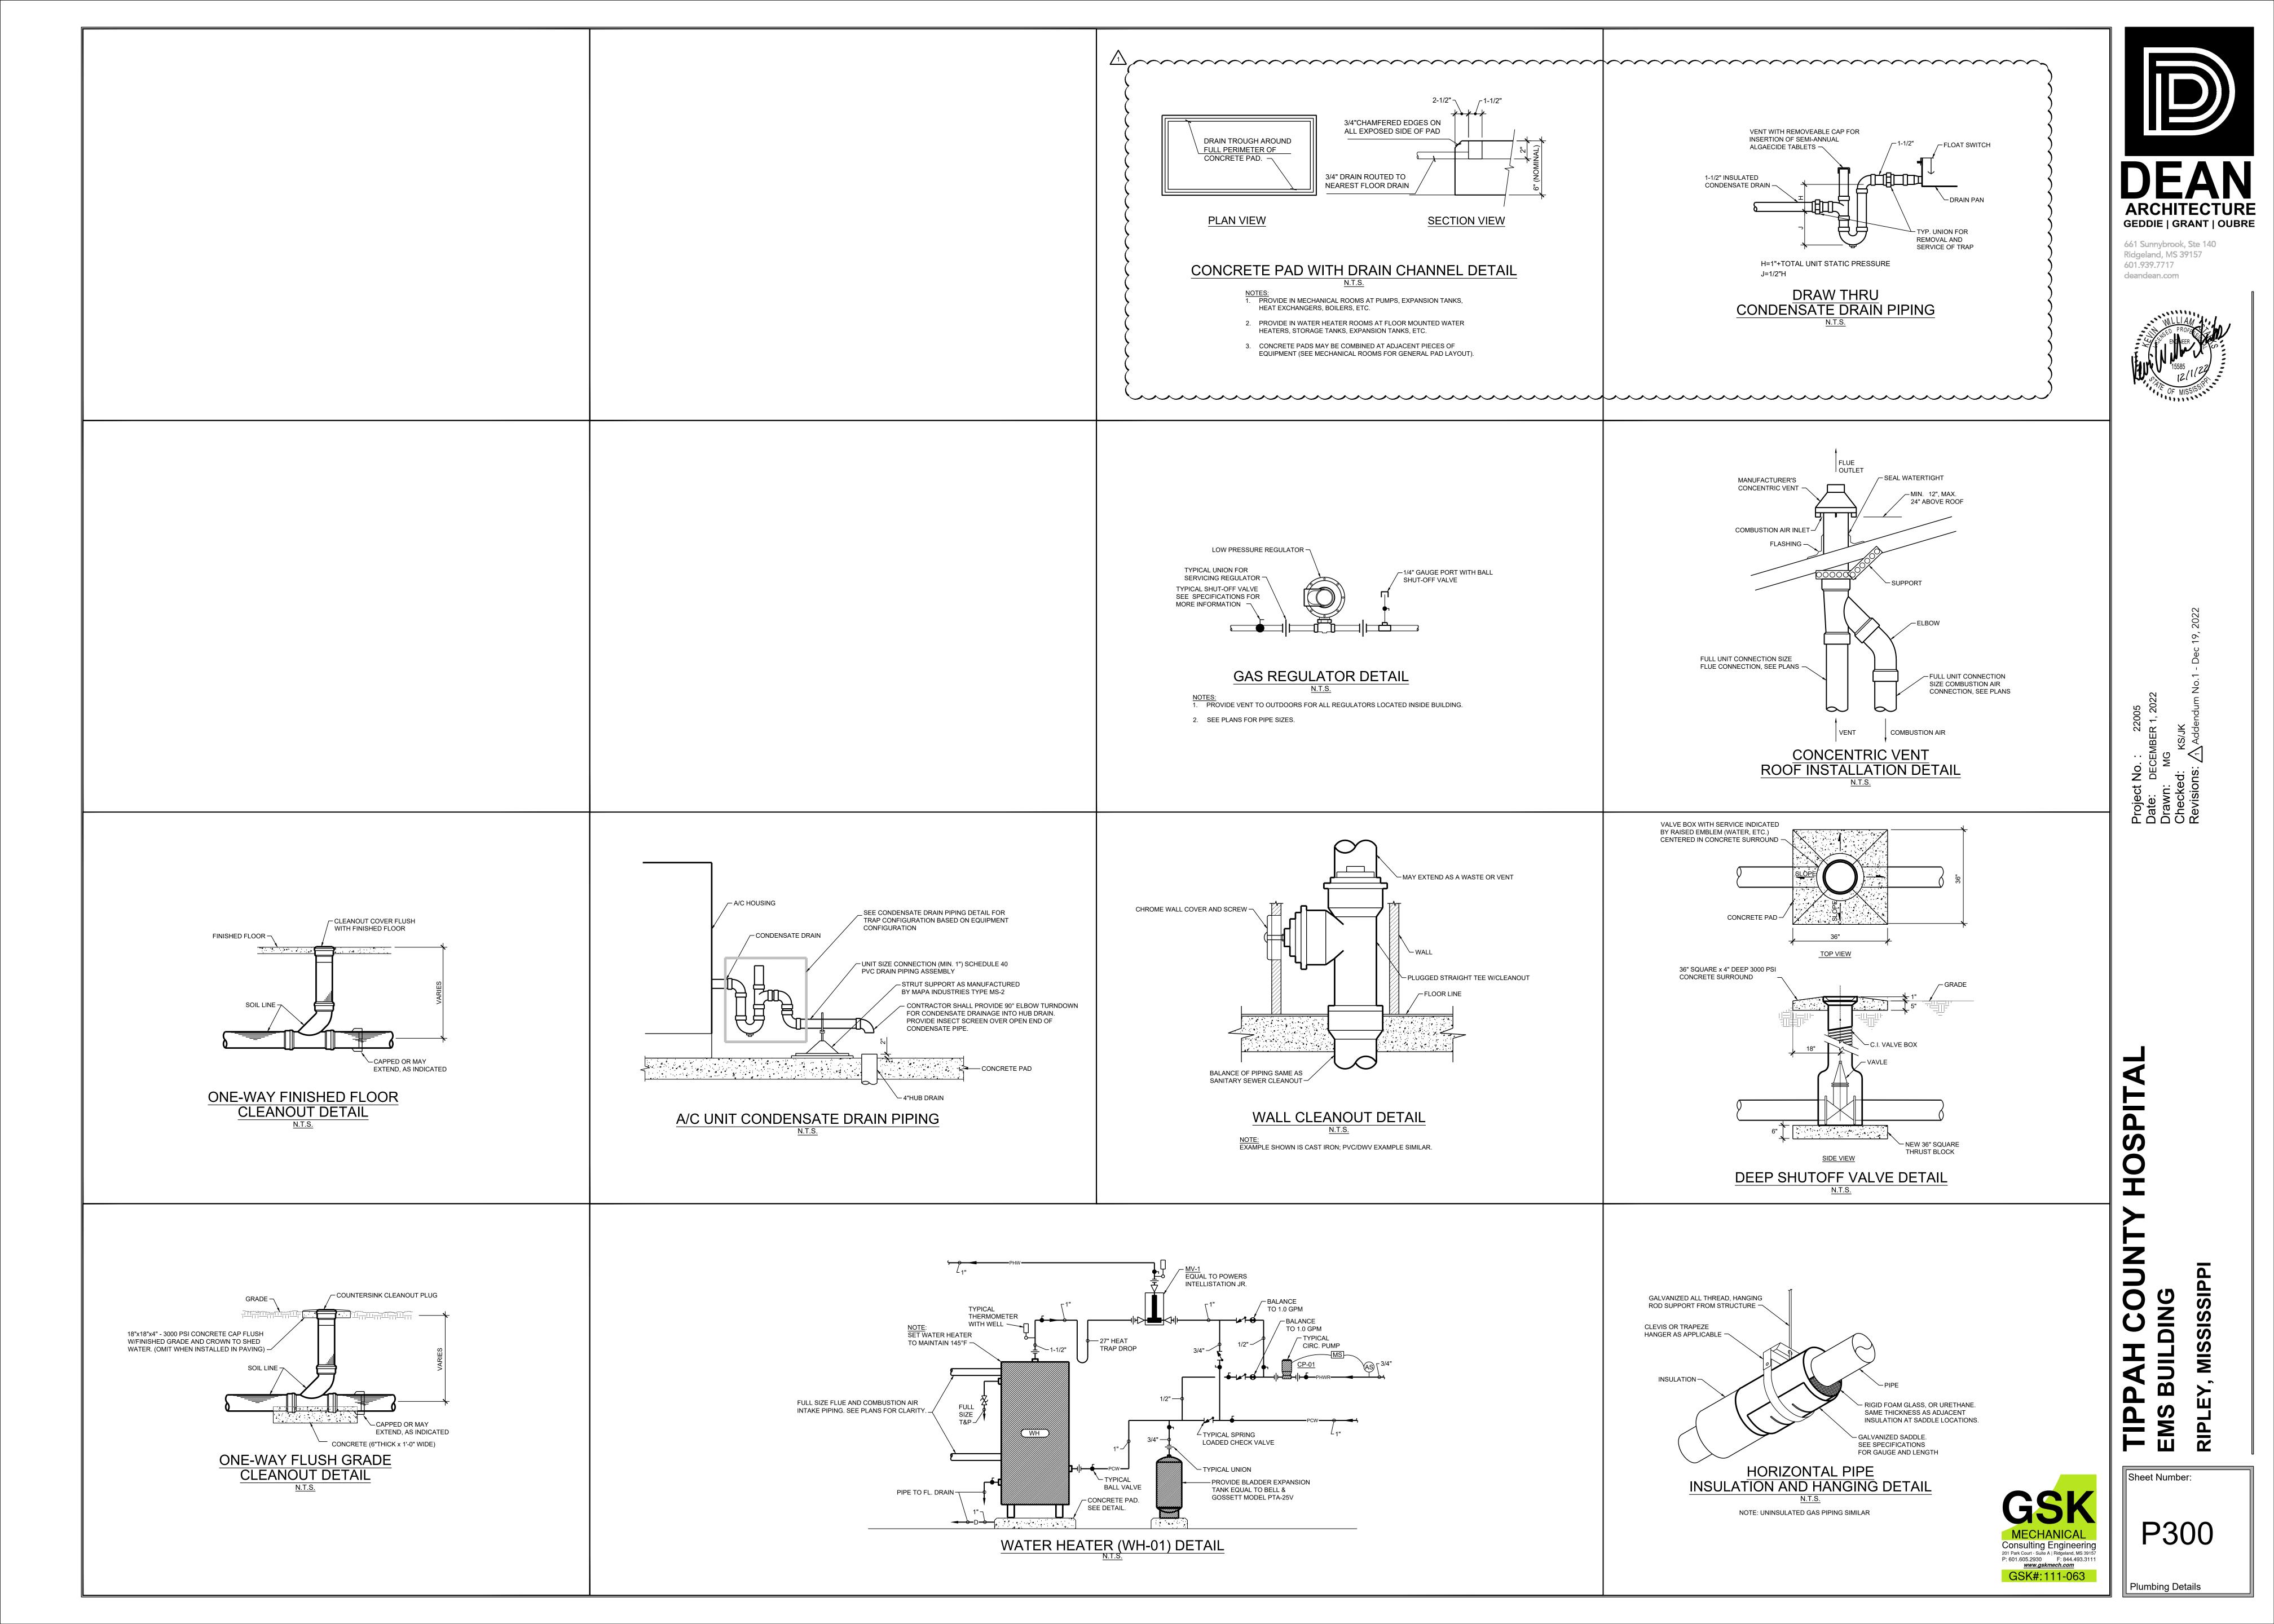
AH COUNTY HOSPITAL


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Consulting Engineering
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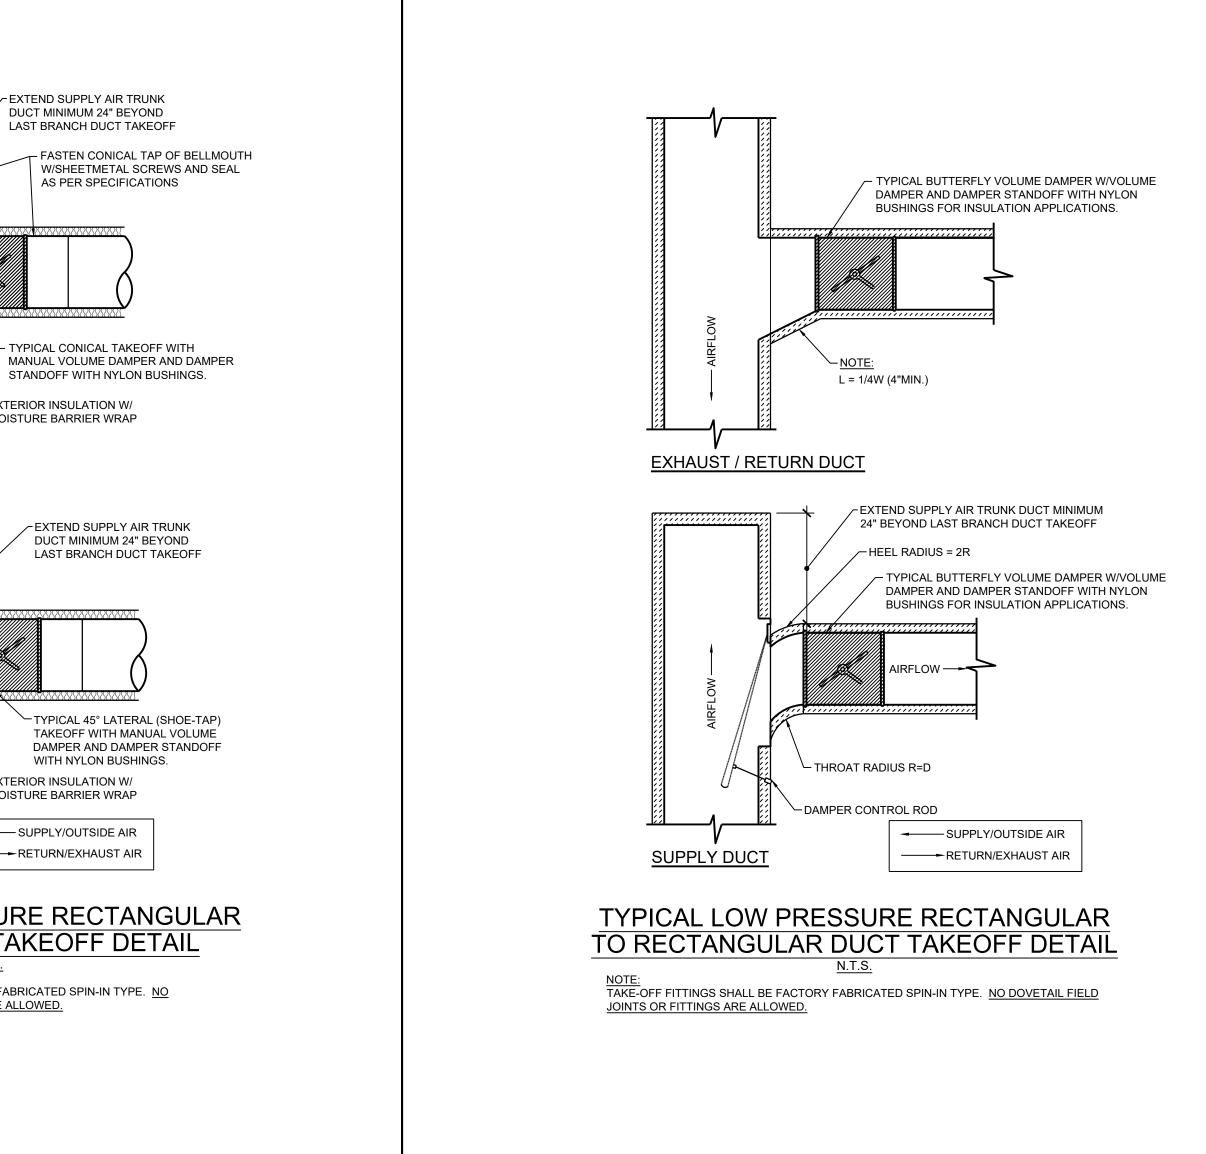
Plumbing Schedules


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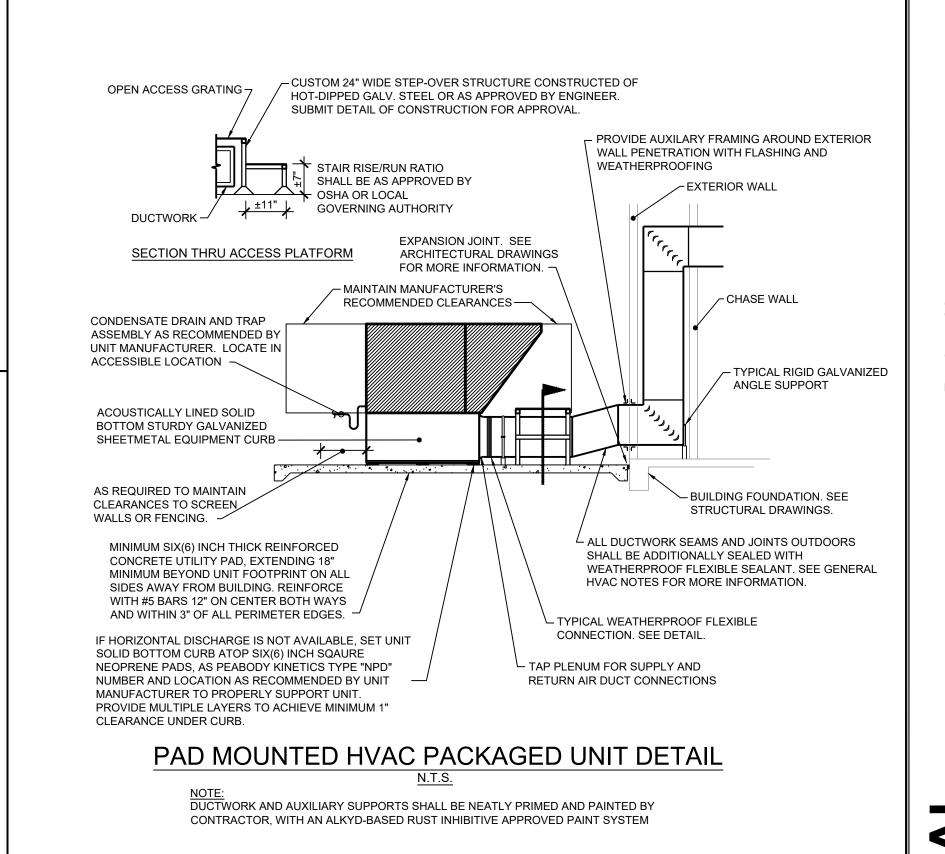





INLINE ABOVE CEILING EXHAUST FAN DETAIL




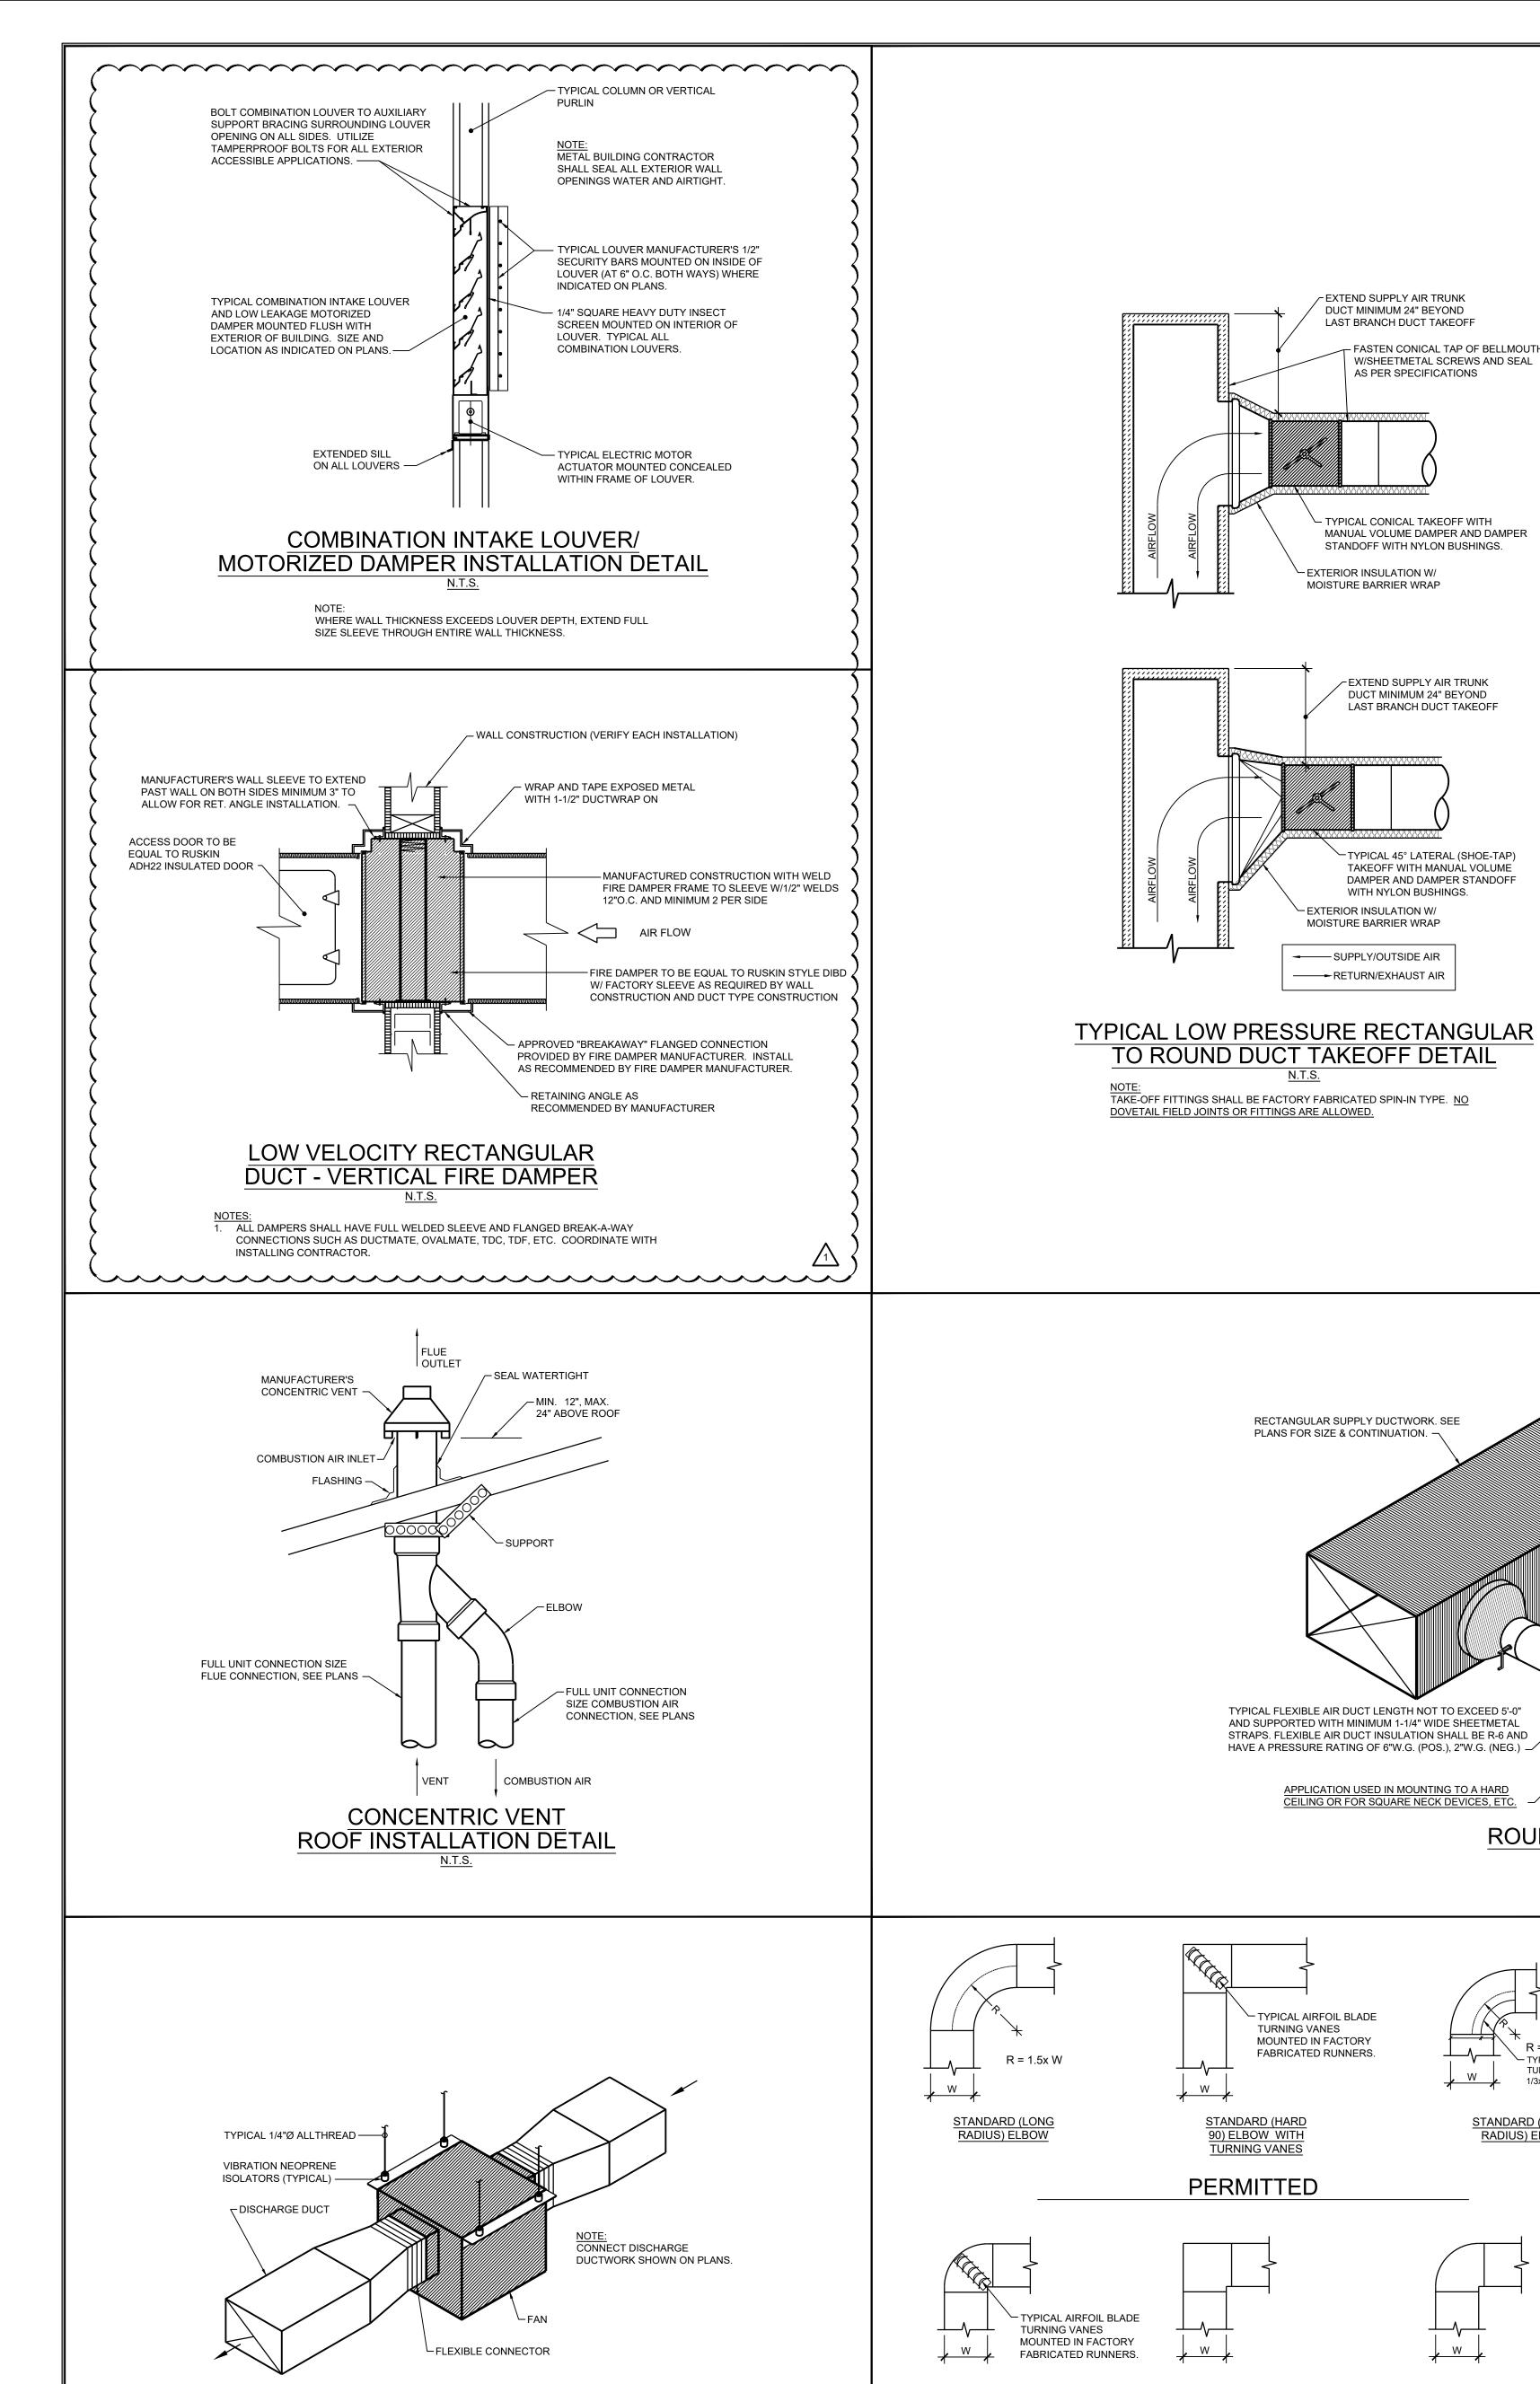

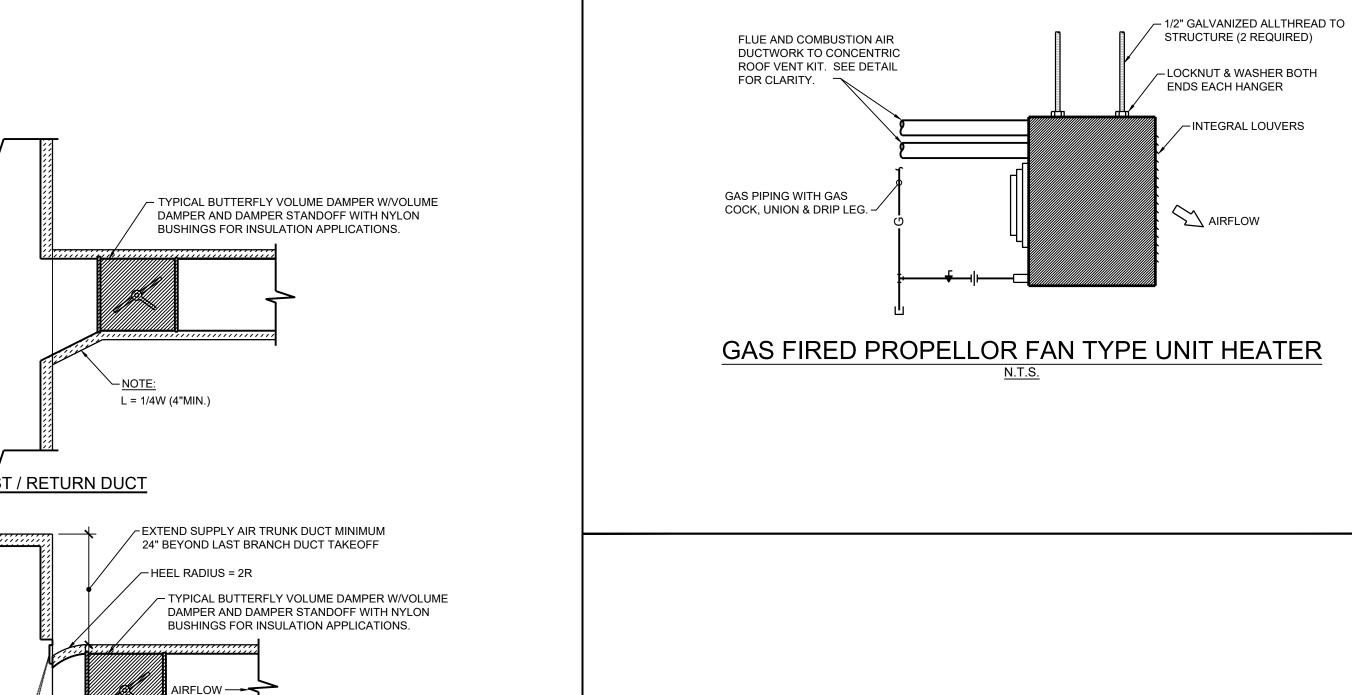

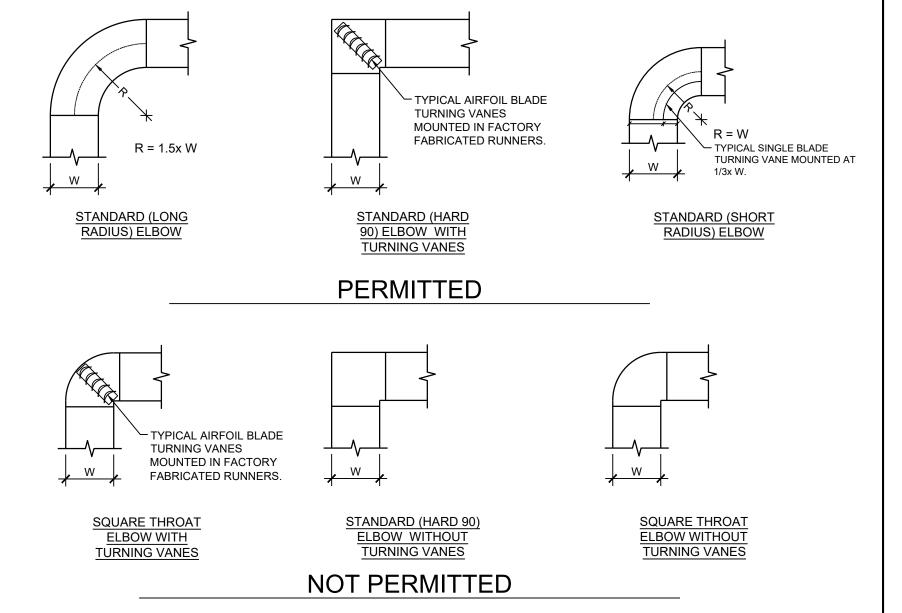

RECTANGULAR DUCT ELBOW DETAIL

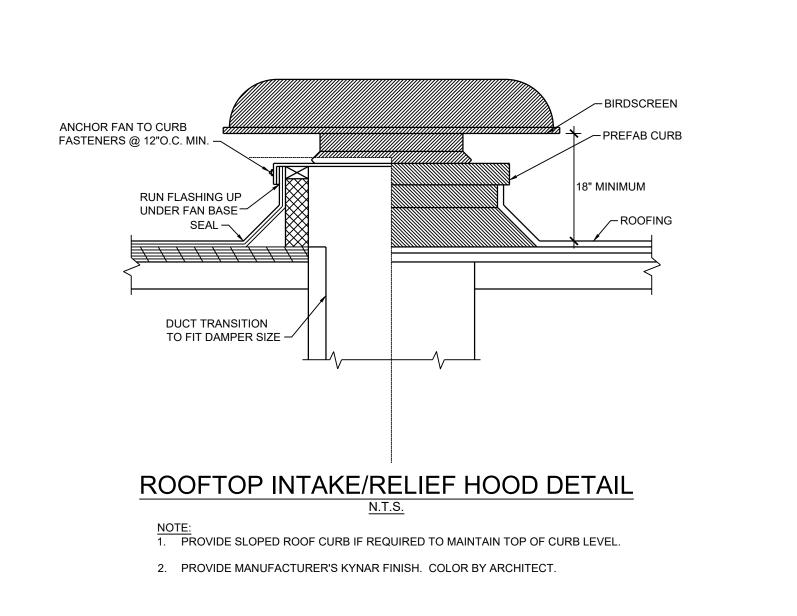

TYPICAL EXTERNALLY INSULATED METAL DUCT. LONGITUDINAL

END CONNECTIONS. DUCTWORK TO BE SCREWED EVERY 4"O.C.

FLEXIBLE DUCTWORK CONNECTIONS.

ON CIRCUMFERENTIAL SEAMS AND AT FITTING JOINTS.

SEAMS SHALL BE SCREWED EVERY 18"O.C. AND MINIMUM 6" FROM

PROVIDE GENEROUS COATING OF ELASTOMERIC DUCT

SEAMS AND CONNECTIONS SEALED AIRTIGHT

AIR DISTRIBUTION DEVICE. SEE

PLANS FOR AIR PATTERN

APPLICATION USED IN MOUNTING IN A LAY-IN TILE CEILING.

PROVIDE 1-1/2"-3/4 P.C.F. DENSITY

ALL AIR DISTRIBUTION DEVICES

MIN. 6" HIGH INTERIOR INSULATED SHEETMETAL PLENUM SAME SIZE AS NECK OF SUPPLY AIR DIFFUSER.

ROUND NECK DIFFUSER DETAIL


SUPPORT WITH WOOD/METAL FRAMING ON ALL SIDES.

FIBERGLASS DUCTWRAP WITH F.S.K. ATOP

TYPICAL RIGID ELBOW (OR FLEX DUCT WITH ELBOW

SUPPORT AS THERMOFLEX FLEXFLOW ELBOW). ALL

SEALANT ON MALE ENDS OF DUCT FITTINGS, AND

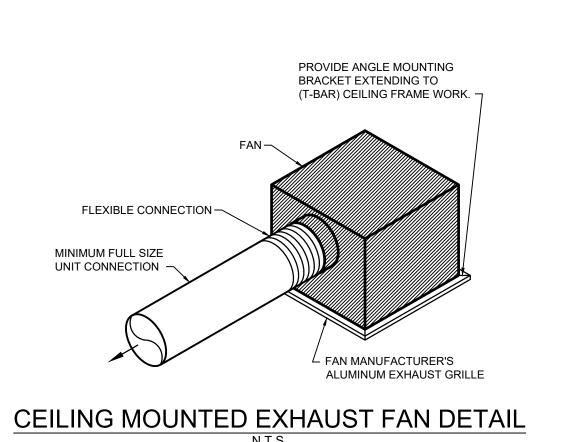



TIPP, EMS B Sheet Number: M300 HVAC Details


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Sheet Number:

E101

SITE PLAN -ELECTRICAL

KEYNOTES (LIGHTING)

ROUTE CIRCUIT VIA PHOTOCELL EQUAL TO TORK #2101. MOUNT PHOTOCELL ON ROOF FACING NORTH AVOIDING ANY SOURCE OF ARTIFICIAL LIGHT AT NIGHTTIME.

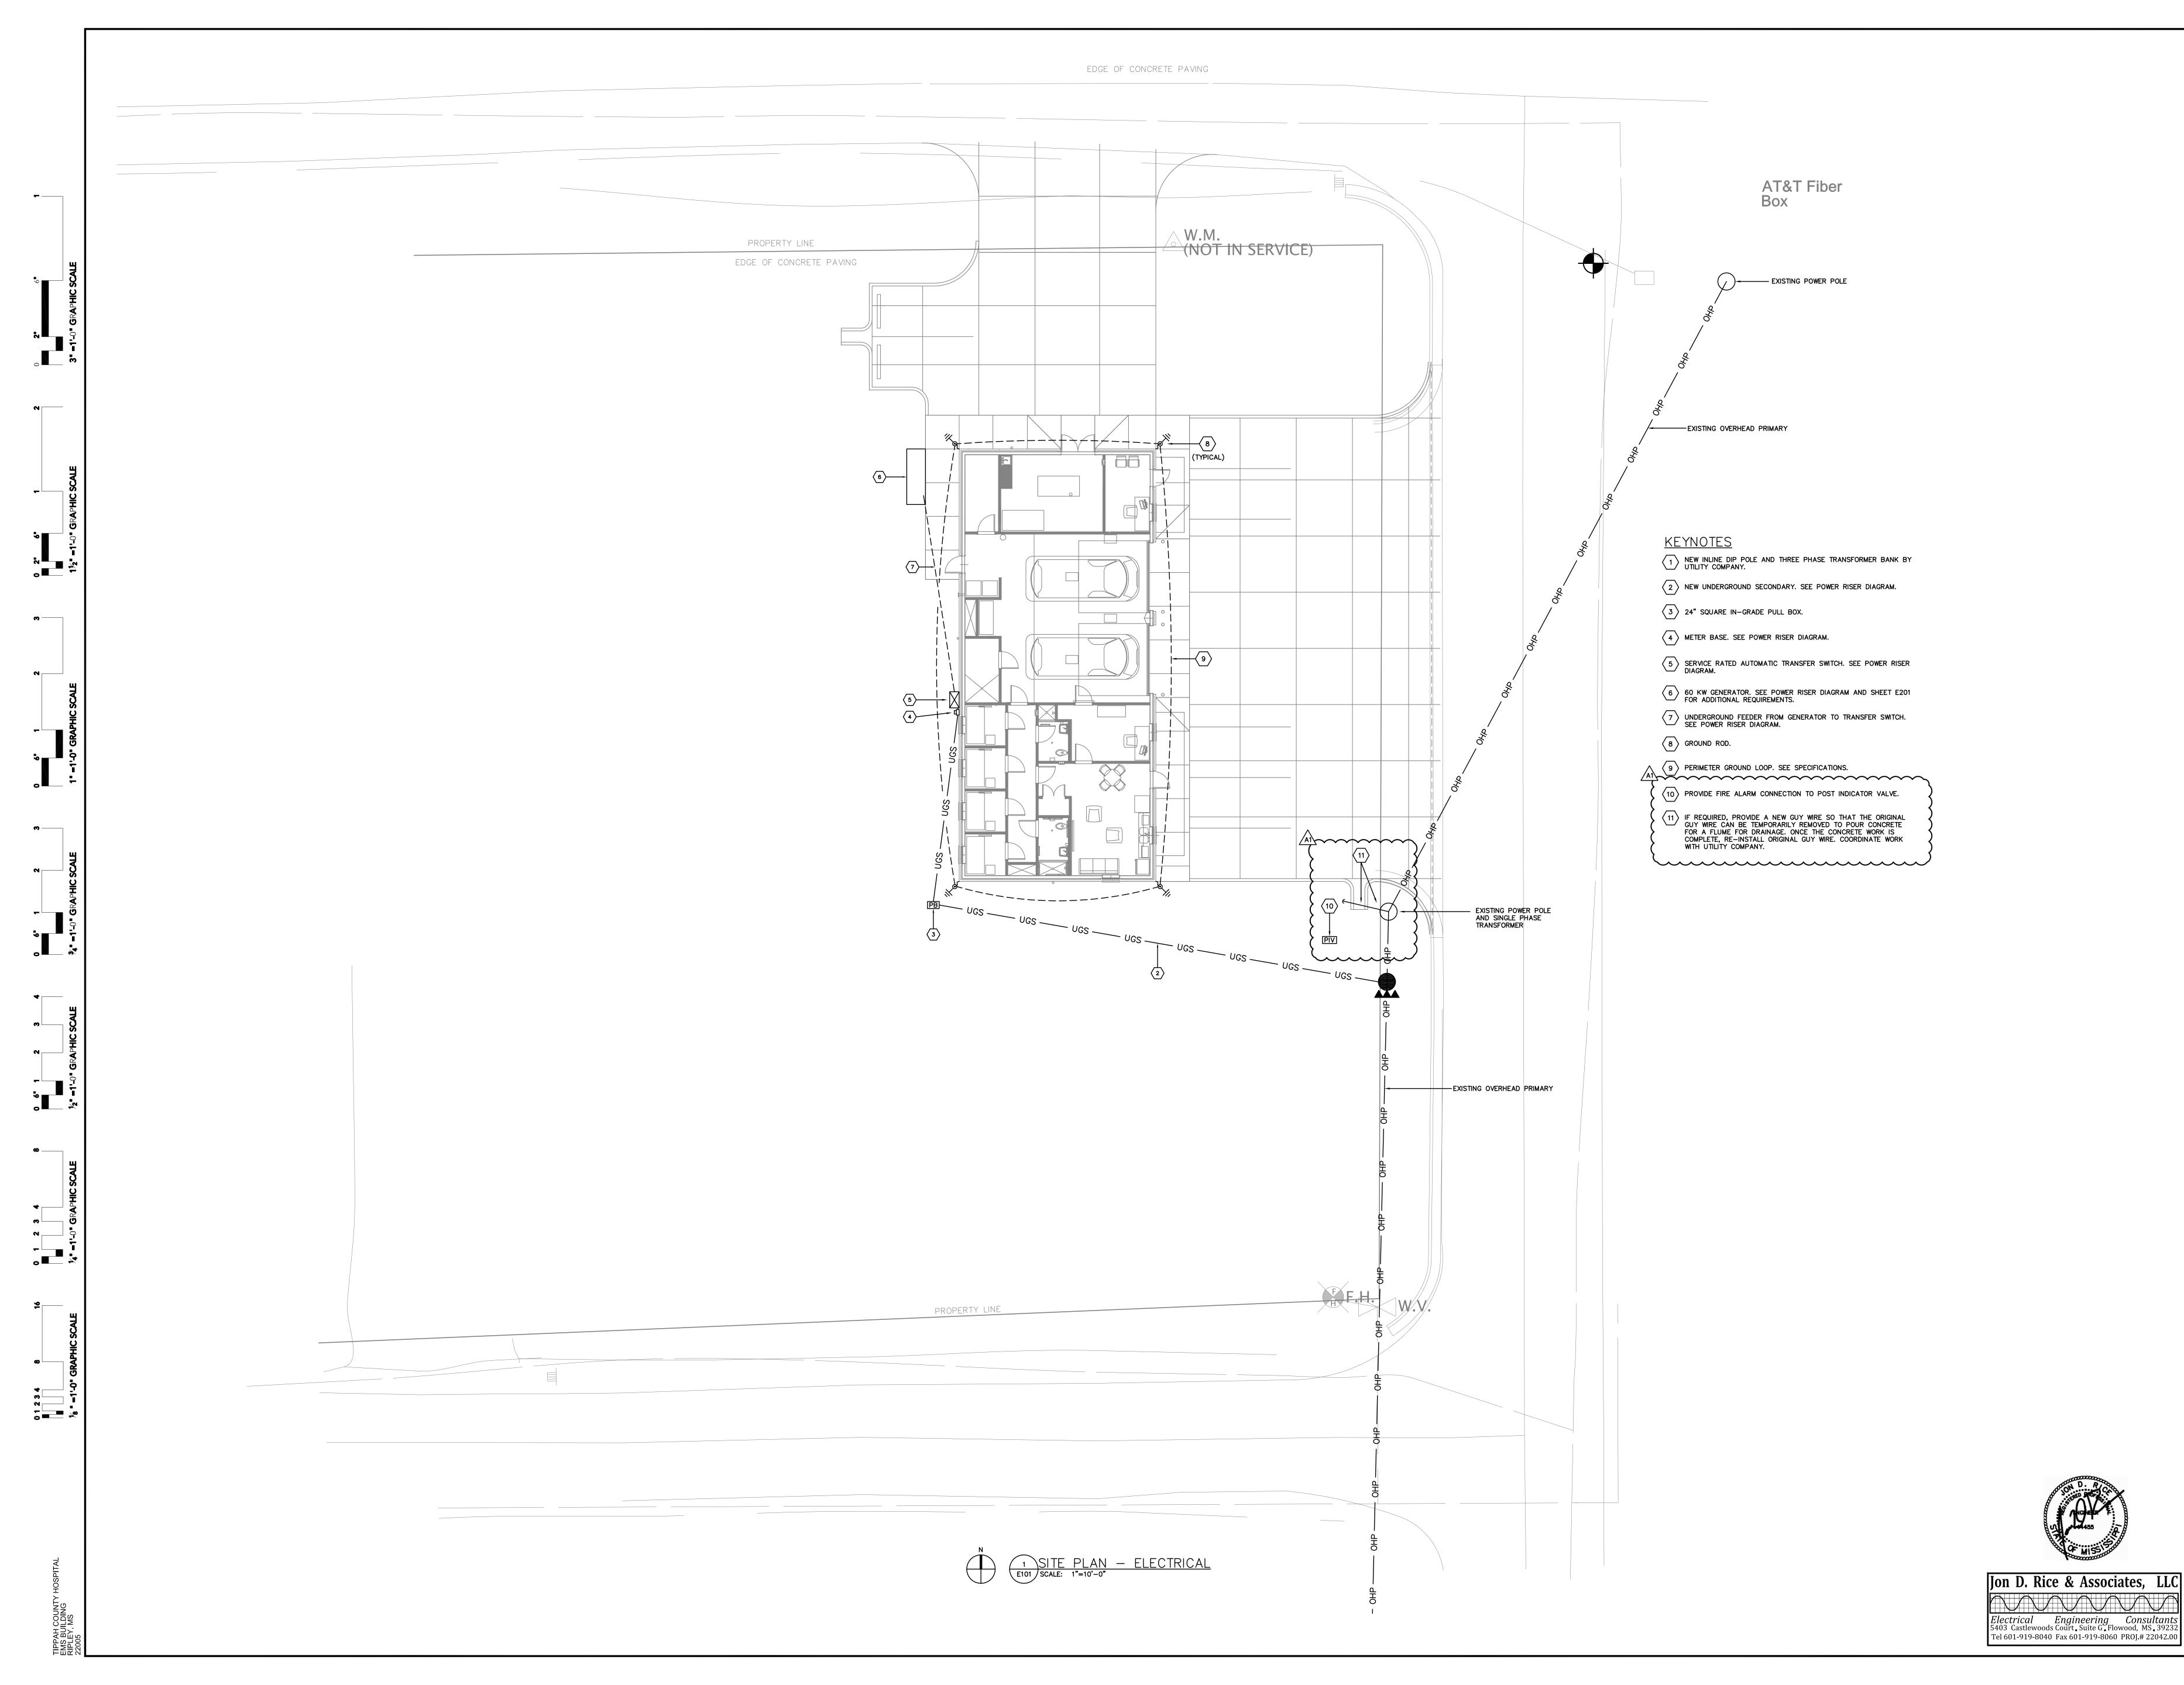GENERAL NOTE

THE NEW AUTOMATIC TRANSFER SWITCH SHALL BE INCLUDE UNDER THE BASE BID. THE GENERATOR SHALL BE INCLUDED UNDER ADD ALTERNATE #2.

- KEYNOTES (POWER & SYSTEMS)
- 1 NEW PANEL DP
- 2 FIRE ALARM CONTROL PANEL.
- TELECOM BACKBOARD. PROVIDE COPPER GROUND BUS BAR ON STANDOFF INSULATORS ON TELECOM BACKBOARD. BOND ALL FRAMES, CABLE TRAYS, AND CABINETS TO THIS GROUND BUS WITH #6 AWG COPPER GROUNDING CONDUCTOR.
- 4 WALL MOUNT TELECOM RACK BY OWNER.
- PROVIDE NEMA L5-30R RECEPTACLE FOR RACK MOUNT UPS. COORDINATE EXACT LOCATION WITH OWNER AND GENERAL CONTRACTOR PRIOR TO ROUGH-IN.
- 6 PROVIDE NEMA 14-30R RECEPTACLE FOR DRYER. COORDINATE MOUNTING HEIGHT WITH OWNER PRIOR TO ROUGH-IN.
- 7 METER BASE.
- 8 NEW SERVICE RATED AUTOMATIC TRANSFER SWITCH.
- 9 PROVIDE RECEPTACLE, CORD, AND PLUG AS DISCONNECTING MEANS FOR WATER HEATER.
- PROVIDE MOTOR RATED SWITCH AS DISCONNECTING MEANS FOR CIRCULATION PUMP CP-01.
- PROVIDE 1" CONDUIT FROM GENERATOR TO ATS FOR GENERATOR CRANK CIRCUITS AND FAULT INDICATOR PANEL.
- PROVIDE MOTOR RATED SWITCH AS DISCONNECTING MEANS FOR UNIT HEATER EH-01.

 PROVIDE MOTOR RATED SWITCH AS DISCONNECTING MEANS FOR MOTOR OPERATED DAMPER.
- CONNECT EXHAUST FAN TO SWITCHED LIGHTING CIRCUIT IN TOILET.
- 15 GENERATOR FAULT INDICATOR PANEL.
- A1

 16 FIRE SUPPRESSION SYSTEM RISER BELL. PROVIDE 120V
 CONNECTION TO BELL. FIELD VERIFY EXACT LOCATION AND
 MOUNTING HEIGHT WITH MECHANICAL CONTRACTOR PRIOR TO



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1 FLOOR PLAN — POWER & SYSTEMS E201 SCALE: 1/4"=1'-0"

DING

Sheet Number:

FLOOR PLAN -ELECTRICAL

E201

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¼" =1'-0" GRAPHIC SC

18 = 1'-0" GRAPHIC SCALE

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